

# GULF COAST STATE COLLEGE PHASE 3 CAMPUS IMPROVEMENTS

5230 US-98 PANAMA CITY, FLORIDA 32401

### CONSTRUCTION DOCUMENTS

**PROJECT SUMMARY** 

**CODE REVIEW ANALYSIS** 

PANEL RISER DIAGRAM AND SCHEDULE

#### DEVELOPMENT AND CONSTRUCTION OF NEW ROADS AND PARKING AREAS, THE INSTALLATION OF NEW LIGHTING AND SIGNAGE. AREA "B' AREA "A" **CLASSIFICATION OF WORK NEW CONSTRUCTION INDEX OF DRAWINGS:** Tommon many ARCHITECTURAL **COVER SHEET** A0.1 SIGNAGE CIVIL C1 **COVER SHEET GENERAL NOTES** OVERALL SITE PLAN OVERALL EXISTING CONDITIONS MAP **EXISTING CONDITION MAPS** OVERALL DEMOLITION PLAN C8-9 DEMOLITION PLANS C10 **EROSION CONTROL PLAN** C11 SWPPP PLAN SWPPP DETAILS C12 OVERALL GEOMETRY PLAN C153 SITE GEOMETRY PLANS PLAN AND PROFILE STORMWATER FACILITY PLAN AND DETAILS C18-19 SITE GRADING PLANS C20 OVERALL UTILITY PLAN C21-22 UTILITY PLANS OVERALL SIGNAGE AND STRIPING PLAN C23 SIGNAGE AND STRIPING PLANS SIGNAGE DETAILS C26 MISCELLANEOUS DETAILS LANDSCAPE **ELECTRICAL** ELECTRICAL LEGEND, FIXTURE SCHEDULE AND NOTES **DEMOLITION PLAN AREA "A"** E3 DEMOLITION PLAN AREA "B" E4 NEW WORK PLAN AREA "A" NEW WORK PLAN AREA "B" ELECTRICAL DETAILS

### PROJECT DIRECTORY:

#### **ARCHITECTURAL**

FLORIDA ARCHITECTS, INC. 648 FLORIDA AVE. PANAMA CITY, FL 32401 PHONE: 850.257.5400

203 ABERDEEN PARKWAY PANAMA CITY, FL 32405 PHONE: 850.522.0644

#### **ELECTRICAL**

216 EAST GOVERMENT STREET PENSACOLA, FL 32502 PHONE: 850.462.8040

#### LANDSCAPE ARCHITECT

LAWNSCAPES, INC. P.O.BOX 1726 PANAMA CITY, FL 32404 PHONE: 850.763.2975



CLIENT: CONSULTANTS:



**Dew**berry PREBLE-RISH



CLIENT:

**GULF COAST STATE** COLLEGE

> 5230 US-98 PANAMA CITY, **FLORIDA 32401** 850.169.1551 gulfcoast.edu

PROJECT: GCSC PHASE 3 CAMPUS IMPROVEMENTS ITB#8-2016/2017



WITH PROFESSIONAL ENGINEERS SEAL

RELEASE:

CONSTRUCTION DOCUMENTS

SCALE:		DATE: 05/03/17						
DRAWN	I: R.DAVIS	CHECKED: J	.SORCI					
NO.	REVISION		DAT					

SHEET TITLE: **COVER SHEET** 

**PROJECT** 

4166-15

A0.0



COLLEGIATE DRIVE DS-4 DOUBLE SIDED — DS-6 DOUBLE SIDED — DS-5 DOUBLE SIDED DS-3
DOUBLE
SIDED DS-2 DOUBLE SIDED RELEASE: ENTER THE PROJECT NAME SCALE: 1" = 50'-0" DRAWN: R.DAVIS NO. REVISION EXISTING PARKING LOT **EXISTING PARKING LOT** — DS-1 DOUBLE SIDED SIGNAGE 1" = 50'-0"

**Dew**berry PREBLE-RISH

203 ABERDEEN PKWY, PANAMA CITY, FL 32405 (850) 522-0644





CLIENT:

GULF COAST STATE COLLEGE

5230 US-98 PANAMA CITY, FLORIDA 32401 850.169.1551 gulfcoast.edu

PROJECT: GCSC PHASE 3 CAMPUS IMPROVEMENTS

ITB # 8 - 2016/2017



CONSTRUCTION DOCUMENTS

DATE: 05/05/17 CHECKED: J.SORCI

SHEET TITLE:

PROJECT 4166-15

SHEET A0.1

PHASE 3

### CONSTRUCTION PLANS FOR:

# CAMPUS IMPROVEMENTS - PHASE III

PREPARED FOR:

# GULF COAST STATE COLLEGE

### PREPARED BY:





203 ABERDEEN PKWY, PANAMA CITY, FL 32405 (850) 522-0644

> PROJECT NUMBER - 50090785 MAY 2017

### BID No. ITB#8-2016/2017

100% CONSTRUCTION DOCUMENTS									
REV. NO.	REV. DATE	REVISION DESCRIPTION	RELEASED TO	RELEASE DATE					

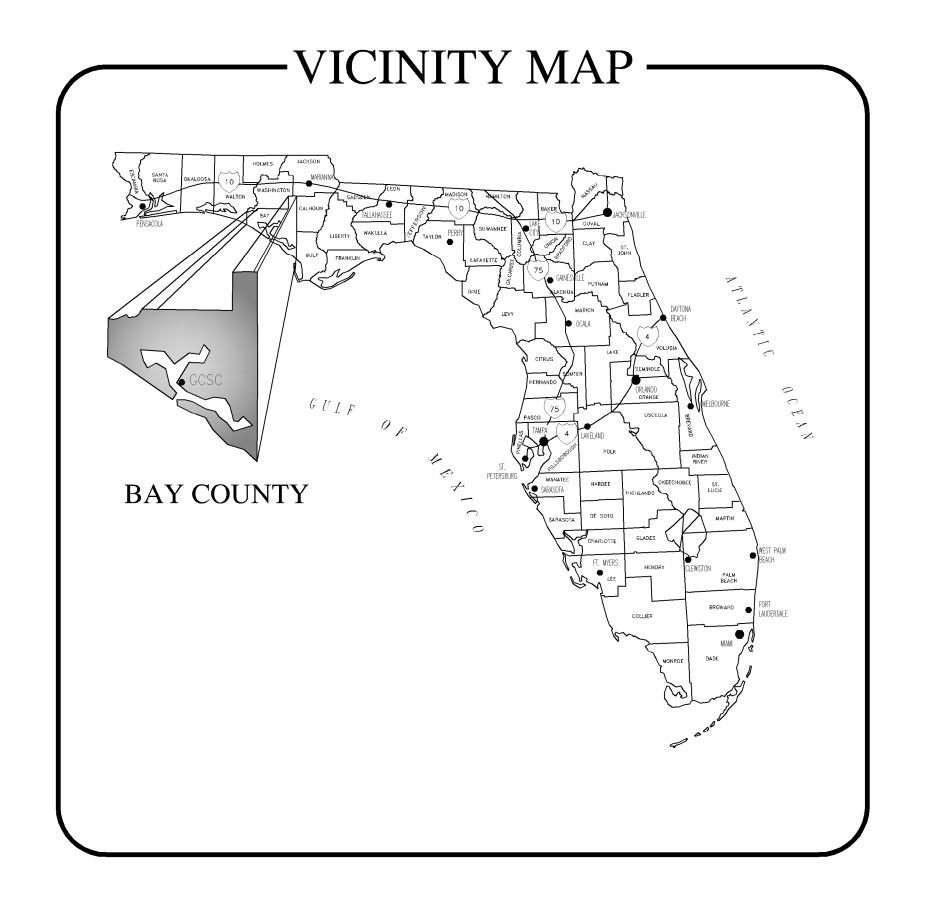

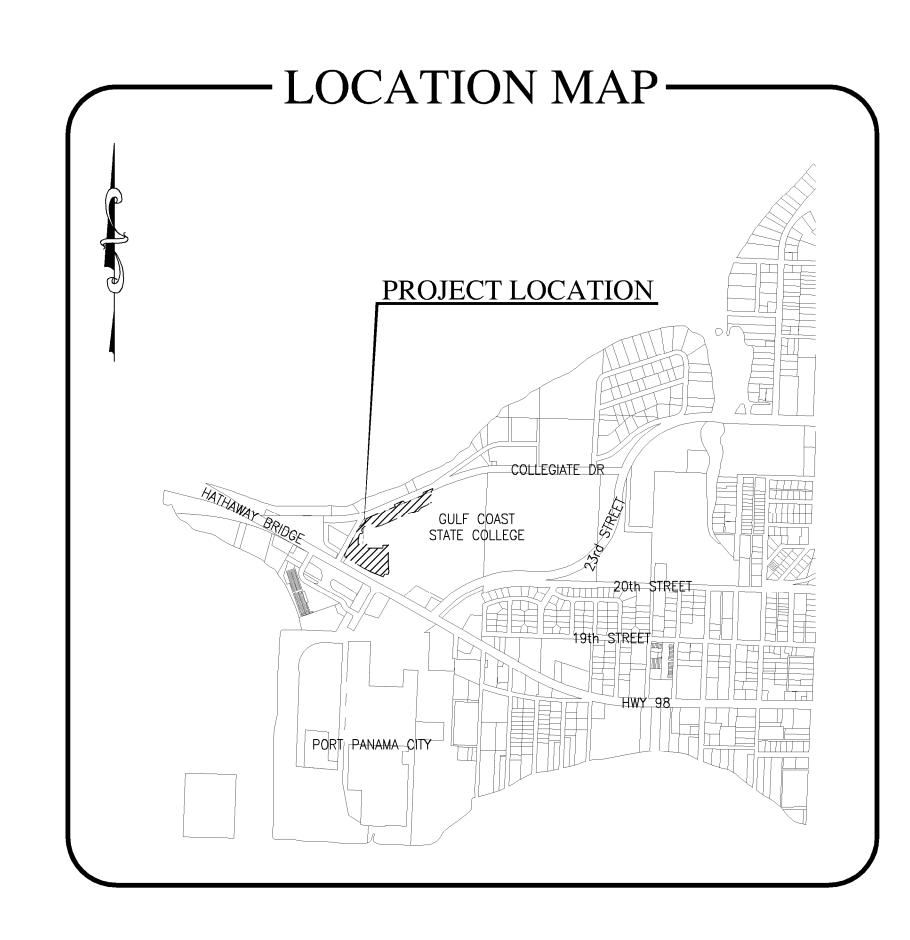

#### -DRAWING INDEX -TITLE NO. **COVER SHEET** GENERAL NOTES C3 OVERALL SITE PLAN -AERIAL OVERALL EXISTING CONDITIONS MAP C4 **EXISTING CONDITIONS MAPS** C5-C6 OVERALL DEMOLITION PLAN **DEMOLITION PLANS** C8-C9 EROSION CONTROL PLAN C10 SWPPP PLAN SWPPP DETAILS OVERALL GEOMETRY PLAN SITE GEOMETRY PLANS C14-C15 PLAN AND PROFILE C16 STORMWATER FACILITY PLAN AND DETAILS C18-C19 SITE GRADING PLANS OVERALL UTILITY PLAN C20 UTILITY PLANS C21-C22 OVERALL SIGNAGE AND STRIPING PLAN C23 SIGNAGE AND STRIPING PLANS C24-C25 SIGNAGE DETAILS C26 MISCELLANEOUS DETAILS D1-D2

- 1. THE BENCHMARK DATUM USED FOR THE PLANS IS NAVD88.
- 2. ANY PUBLIC LAND CORNER OR MONUMENT THAT PERPETUATES BAY COUNTY RIGHT OF WAY WITHIN THE PROJECT LIMITS IS TO BE PROTECTED BY THE CONTRACTOR. IF A MONUMENT IS IN DANGER OF BEING DESTROYED THE CONTRACTOR IS TO ENSURE THAT IT IS PROPERLY REFERENCED AND RESET PRIOR TO PROJECT COMPLETION. THE MONUMENTS SET SHALL MEET MINIMUM TECHNICAL STANDARDS AS DEFINED IN 61G17, F.A.C. AND CURRENT BAY COUNTY SURVEYING STANDARDS.
- 3. ALL WORK SHALL BE PERFORMED IN ACCORDANCE WITH FDOT 2013 DESIGN STANDARDS AND STANDARD SPECIFICATIONS FOR ROAD AND BRIDGE CONSTRUCTION, UNLESS OTHERWISE STATED OR SHOWN IN THE PLANS.
- 4. ALL WORK SHALL BE PERFORMED IN ACCORDANCE WITH THE CITY OF PANAMA CITY STANDARDS AND SPECIFICATIONS, UNLESS APPROVED BY THE CITY OF PANAMA CITY.
- 5. THE CONTRACTOR SHALL NOT BRING ANY HAZARDOUS MATERIALS ONTO THE PROJECT. SHOULD THE CONTRACTOR REQUIRE SUCH MATERIALS FOR PERFORMING THE CONTRACTED WORK, THE CONTRACTOR SHALL REQUEST, IN WRITING, WRITTEN PERMISSION FROM THE PROJECT ADMINISTRATOR. THE CONTRACTOR SHALL PROVIDE THE PROJECT ADMINISTRATOR WITH A COPY OF THE MATERIAL SAFETY DATA SHEET (MSDS) FOR EACH HAZARDOUS MATERIAL PROPOSED FOR USE. THE CONSTRUCTION PROJECT ADMINISTRATOR SHALL COORDINATE WITH THE ENGINEER OF RECORD PRIOR TO ISSUING WRITTEN APPROVAL TO THE CONTRACTOR. SINCE STATE LAW DOES NOT TREAT PETROLEUM PRODUCTS THAT ARE PROPERLY CONTAINERIZED AND INTENDED FOR EQUIPMENT USE AS A HAZARDOUS MATERIAL, SUCH PRODUCTS DO NOT NEED A MSDS SUBMITTAL.
- 6. ANY KNOWN OR SUSPECTED HAZARDOUS MATERIAL FOUND ON THE PROJECT SHALL IMMEDIATELY BE REPORTED TO THE CONSTRUCTION PROJECT ADMINISTRATOR WHO SHALL DIRECT THE CONTRACTOR TO PROTECT THE AREA OF KNOWN OR SUSPECTED CONTAMINATION FROM FURTHER ACCESS. THE CONSTRUCTION PROJECT ADMINISTRATOR IS TO NOTIFY THE PROJECT MANAGER OF DISCOVERY. THE PROJECT MANAGER WILL ARRANGE AN INVESTIGATION, IDENTIFICATION AND REMEDIATION OF THE HAZARDOUS MATERIAL. THE CONTRACTOR SHALL NOT RETURN TO THE AREA OF CONTAMINATION UNTIL APPROVAL IS PROVIDED BY THE CONSTRUCTION PROJECT ADMINISTRATOR.
- 7. THE CONTRACTOR SHALL NOTIFY UTILITY OWNERS THROUGH SUNSHINE ONE CALL OF FLORIDA, INC. TWO BUSINESS DAYS IN ADVANCE OF BEGINNING CONSTRUCTION ON THE JOB SITE. CALL 1-800-432-4770 AND 811 (NATIONWIDE TOLL FREE UTILITY LOCATE). THE LOCATION OF THE UTILITIES SHOWN ON THE PLANS ARE APPROXIMATE ONLY. THE EXACT LOCATION SHALL BE DETERMINED BY THE CONTRACTOR DURING CONSTRUCTION.
- INFORMATION SHOWN ON THE PLANS CONCERNING THE TYPE AND LOCATION OF UNDERGROUND AND OVERHEAD UTILITIES IS BASED ON DATA PROVIDED BY UTILITY OWNERS, AVAILABLE RECORDS, AND FIELD SURVEYS. THE PLANS MAY NOT SHOW ALL UTILITIES WITHIN PROJECT LIMITS, EITHER ACTIVE OR PLACED OUT-OF-SERVICE, OR THAT SAID UTILITIES ARE ACTUALLY IN THE HORIZONTAL OR VERTICAL POSITIONS SHOWN IN THE PLANS. DETERMINE THE TYPE AND LOCATION OF ALL UTILITIES TO ESTABLISH THEIR LOCATIONS AND TO AVOID DAMAGE TO UNDERGROUND UTILITIES.
- 9. UTILITY ADJUSTMENTS ARE TO BE PERFORMED BY THE UTILITY OWNERS UNLESS OTHERWISE NOTED.
- 10. SWEEPING SHALL OCCUR DAILY OR AFTER SUCH EVENTS AS CAUSE TRACKING ONTO STREET.
- 11. ALL PROPOSED GROUND ELEVATIONS ARE FINISHED SOD ELEVATIONS. FINISH EARTHWORK GRADING SHALL BE 0.2 FEET BELOW ELEVATIONS SHOWN TO ALLOW FOR SOD THICKNESS.
- 12. SODDING INCLUDES MAINTAINING SLOPES AND SOD UNTIL COMPLETION AND ACCEPTANCE OF TOTAL PROJECT OR GROWTH IS ESTABLISHED, WHICHEVER COMES LAST. UNTIL THEN, ALL EROSION, SILTATION AND MAINTENANCE OF GRADES IS THE RESPONSIBILITY OF THE CONTRACTOR.
- 13. WHERE EXCAVATIONS ARE IN CLOSE PROXIMITY OF TREES NOT SHOWN AS BEING REMOVED, THE CONTRACTOR SHALL USE EXTREME CARE IN NOT DAMAGING THE ROOT SYSTEM. NO EQUIPMENT, SUPPLIES, OR VEHICLES SHALL BE STORED OR PARKED WITHIN THE DRIP LINE OF TREES TO REMAIN AND BE PRESERVED. IT SHALL BE THE RESPONSIBILITY OF THE CONTRACTOR TO INFORM ALL EMPLOYEES AND SUBCONTRACTORS OF THIS REQUIREMENT AND TO ENFORCE SAME.
- 14. PROPOSED CONSTRUCTION SHALL COMPLY WITH THE AMERICANS WITH DISABILITIES ACT (ADA), THE ADA COMPLIANCE HANDBOOK, LATEST EDITION, AND THE FLORIDA ACCESSIBILITY CODE. SIDEWALK CONSTRUCTION AND EXPANSION JOINT SPACING SHALL BE IN ACCORDANCE WITH FDOT DESIGN STANDARD INDEX 310.
- 15. ALL INLETS SHALL BE PROTECTED AS PER FDEP BEST MANAGEMENT PRACTICES, AND THE FDEP/FDOT EROSION AND SEDIMENT CONTROL HANDBOOK.
- 16. THE CONTRACTOR SHALL PROTECT ALL GRASSED AREAS FROM DISCARDED CONCRETE AND EXCESS MATERIALS. ALL DISCARDED CONCRETE AND EXCESS MATERIALS SHALL BE REMOVED FROM THE RIGHT-OF-WAY (OR JOB SITE) ON A DAILY BASIS.
- 17. THE CONTRACTOR SHALL DISPOSE OF ALL DEBRIS UPON COMPLETION OF THE PROJECT.
- 18. THE EROSION CONTROL PLAN SHALL BE IN ACCORDANCE WITH THE FDOT/FDEP EROSION & SEDIMENT CONTROL HANDBOOK.
- 19. ALL FILL MATERIAL SHALL BE SELECT FILL AS DEFINED BY FDOT DESIGN STANDARD INDEX 505.
- 20. DEWATERING: SHOULD LOWERING OF GROUNDWATER BE NECESSARY FOR THE INSTALLATION OF CONCRETE STRUCTURES, OR TO PREVENT LATERAL MOVEMENT OF CONCRETE ALREADY PLACED, SUCH LOWERING SHALL BE ACCOMPLISHED BY MEANS OF A WELL POINT SYSTEM OR OTHER APPROVED MEANS, AT CONTRACTOR'S EXPENSE. COMPREHENSIVE PLANS FOR DEWATERING OPERATIONS, IF USED, SHALL BE SUBMITTED BY THE CONTRACTOR PRIOR TO INSTALLATION. THE CONTRACTOR SHALL BE RESPONSIBLE FOR ALL PERMITTING ASSOCIATED WITH DEWATERING.
- 21. THE CONTRACTOR SHALL BE RESPONSIBLE FOR ACQUIRING NPDES PERMIT.
- 22. THE CONTRACTOR SHALL REPAIR OR REPLACE ANY METERS, VALVES, SERVICE LATERALS, FIRE HYDRANTS, MAINS, WATER, WASTEWATER, OR GAS FACILITIES DAMAGED DURING CONSTRUCTION AT NO ADDITIONAL COST.
- 23. ALL PROPOSED INLETS SHALL HAVE 6" SUMP BOTTOMS ,OPEN BOTTOMS SHALL NOT BE ALLOWED IN AREAS WHERE HIGH GROUNDWATER EXISTS.
- 24. ALL DEMOLISHED MATERIALS SHALL BE REMOVED FROM SITE AND DISPOSED OF IN A LEGAL MANNER.
- 25. CONTRACTOR SHALL PROVIDE (5) SIGNED AND SEALED AS-BUILT SURVEYS PREPARED BY A REGISTERED FLORIDA SURVEYOR. A DIGITAL (AUTOCAD) FILE SHALL ALSO BE PROVIDED.

#### **UTILITY GENERAL NOTES:**

- 1. ALL MAINS SHALL BE INSTALLED ACCORDING TO ENGINEERING PLANS AND SPECIFICATIONS.
- 2. ALL VALVES AND MATERIALS SHALL COMPLY WITH AWWA (AMERICAN WATER WORKS ASSOCIATION) STANDARDS, LATEST EDITION
- 3. ALL MAIN LINE VALVES SHALL BE RESILIENT SEATED GATE VALVES.

WITH THREE (3) PHYSICAL FEATURES (LOT CORNERS, TREES, ETC.).

- 4. THE CONTRACTOR WILL BE REQUIRED TO REMOVE & REPLACE ITEMS ENCOUNTERED IN THE FIELD, ie SIGNS, FENCING,
- F OOT, GIG...
- 5. MAINS SHALL HAVE A MINIMUM OF 36" COVER UNLESS APPROVED BY ENGINEER.
  6. CONTRACTOR IS TO FURNISH "AS BUILT PLANS" INDICATING LOCATIONS OF ALL FITTINGS, VALVES, AND DEAD END RUNS
- 7. ALL WATER MAINS SHALL BE DISINFECTED IN ACCORDANCE WITH AWWA C651. PRESSURE TESTING SHALL BE IN ACCORDANCE WITH AWWA C600.
- 8. CONTRACTOR SHALL NOTIFY AND COORDINATE WITH ENGINEER 48 HOURS PRIOR TO PRESSURE TESTING, DISINFECTION, AND BACTERIOLOGICAL TESTING. PRESSURE TESTING SHALL BE VALVE TO VALVE. CONTRACTOR SHALL USE 2" AIR RELEASE VALVE PORTS OR SHALL TAP THE WATER MAIN WITH A 1" TAPPING SADDLE.
- 9. BASE AND BACKFILL MATERIALS SHALL BE EITHER OF THE SAME TYPE AND COMPOSITION AS THE MATERIALS REMOVED, OR OF EQUAL OR GREATER STRUCTURAL ADEQUACY. MATERIALS CONTAMINATED WITH DELETERIOUS SUBSTANCES DURING EXCAVATION SHALL NOT BE USED FOR FILL.
- 10. CONTRACTOR SHALL BE RESPONSIBLE FOR ALL FITTINGS, TAPS, EQUIPMENT AS REQUIRED FOR FLUSHING SYSTEM, PRESSURE TESTING, DISINFECTION, AND BACTERIOLOGICAL TESTING.
- 11. THE CONTRACTOR SHALL BE RESPONSIBLE FOR DETERMINING THE EXACT LOCATION OF EXISTING UTILITIES, AND TO DETERMINE IF OTHER UTILITIES WILL BE ENCOUNTERED DURING THE COURSE OF THE WORK, AND TAKE WHATEVER STEP NECESSARY TO PROVIDE FOR THEIR PROTECTION.
- 12. UTILITIES SHOW ON THE PLAN MAY NOT BE ACCURATE AND ALL UTILITIES MAY NOT BE SHOWN.
- 13. THE CONTRACTOR SHALL NOTIFY ALL UTILITY OWNERS 48 HOURS PRIOR TO COMMENCING CONSTRUCTION AND SHALL VERIFY LOCATION OF ALL UTILITIES PRIOR TO EXCAVATION.
- 14. ALL VALVE BOXES SHALL BE INSTALLED PER DETAIL SHOWN. PRE-CAST VALVE PADS SHALL NOT BE USED. ALL VALVE BOX RISERS SHALL BE DUCTILE IRON, NOT PVC.
- 15. ALL PAVEMENT SHALL BE CUT AND PATCHED IN ACCORDANCE WITH ENGINEERING PLANS AND SPECIFICATIONS.
- 16. ALL CONCRETE ENCASED DUCTILE IRON SHALL BE WRAPPED WITH A PLASTIC MATERIAL AND TAPED TOGETHER BEFORE CONCRETE IS PLACED AROUND THE PIPE.
- 17. WHERE THERE IS LESS THAN 12" CLEARANCE BETWEEN PVC/DI PIPE AND OTHER PIPE OR SPECIFIED AREAS, THE PIPE SHALL BE ENCASED WITH 6" THICKNESS AROUND THE PIPE AND 6' CLEARANCE EACH WAY IN THE AXIAL DIRECTION.
- 18. THE CONTRACTOR SHALL REMOVE AND REPLACE, TO THEIR ORIGINAL NATURE, ALL DISTURBED MATERIALS OR OBJECTS WITHIN THE PATH OF THE NEW UTILITIES AS NECESSARY. ALL REPLACED MATERIALS SHALL BE EQUAL OR BETTER AND SHALL BE APPROVED BY THE ENGINEER. THIS INCLUDES ALL LANDSCAPING WITHIN THE RIGHT OF WAY IN THE PATH OF THE NEW LITHING.
- THE NEW UTILITIES.

  19. THE CONTRACTOR SHALL VISIT THE SITE PRIOR TO BIDDING. THE SURVEY MAY NOT SHOW ALL OBJECTS WITHIN THE PATH OF THE NEW UTILITIES. IF OBJECTS ARE NOT SHOWN ON THE SURVEY, THE CONTRACTOR SHALL NOTIFY THE ENGINEER WITHIN 7 DAYS PRIOR TO THE BID DATE. CONTRACTOR WILL BE RESPONSIBLE FOR REPLACEMENT OF ALL OBJECTS NOT
- SHOWN ON THE SURVEY.

  20. ALL CONSTRUCTION AREAS NEAR WETLANDS ARE TO BE MONITORED CLOSELY FOR EROSION. SILT FENCE AND HAY BALES SHALL BE USED IN THESE AREAS. CONTRACTOR SHALL FOLLOW ALL THE FDEP/COE DREDGE AND FILL PERMIT
- REQUIREMENTS IF APPLICABLE. SEE SPECIFICATIONS.

  21. ALL SPOIL MATERIAL SHALL BE PLACED ON THE UPLAND SIDE OF ANY SLOPED CONSTRUCTION AREA.
- 22. THE CONTRACTOR SHALL TAKE WHATEVER STEPS NECESSARY TO PREVENT EROSION INTO NEARBY WETLANDS.
- 23. THE CONTRACTOR SHALL USE RESTRAINED JOINT PIPE FOR ALL BENDS, TEES, VALVES, AND TRANSITION FITTINGS.
- 24. INSULATED 12 GA. LOCATING WIRE SHALL BE INSTALLED ON TOP OF ALL NON-METALIC PIPE. WHICH INCLUDES SERVICE CONNECTIONS. ALL LOCATING WIRE SHALL BE CONNECTED AND SHALL TERMINATE IN VALVE BOXES AND METER BOXES AS SHOWN IN THE DETAILS.
- 25. ALL PIPE SHALL BE INSTALLED IN DRY CONDITIONS. WELL POINTING MAY BE REQUIRED AT THE DIRECTION OF THE ENGINEER. WELL POINTS OR SOCK PIPE MAY BE USED.
- 26. THE FLUSHING VELOCITY SHALL BE A MINIMUM OF 3 FEET PER SECOND FOR 3 TIMES THE PIPE VOLUME. THE OWNER WILL PAY FOR THE FIRST FLUSH AND PRESSURE TEST WATER. THE CONTRACTOR WILL PAY FOR ANY WATER FOR ADDITIONAL REPAIRS, FLUSHING, AND TESTING. THE CONTRACTOR SHALL PROVIDE ALL TEMPORARY ABOVE GROUND OUTLETS AND VALVES FOR FLUSHING THE PIPES ON THIS PROJECT.
- 27. CONTRACTOR SHALL FOLLOW ALL OSHA REQUIREMENTS FOR CONSTRUCTION.
- 28. THE CONTRACTOR SHALL FOLLOW ALL CONDITIONS OF THE PERMIT REQUIREMENTS. SEE SPECIFICATIONS FOR COPY OF
- 29. ALL DISTURBED AREAS SHALL BE SODDED.
- 30. A ONE FOOT STRIP OF SOD SHALL BE INSTALLED ON THE EDGE OF ALL ASPHALT OVERLAY AREAS AND AROUND ALL ABOVE GROUND CONCRETE STRUCTURES INCLUDING BUT NOT LIMITED TO VALVE PADS, BLOW OFF VAULTS, AND AIR RELEASE
- 31. CONTRACTOR SHALL PROVIDE ALL FITTINGS, SLEEVES AND TRANSITION ADAPTERS AS NECESSARY TO COMPLETE THIS PROJECT.
- 32. CONTRACTOR SHALL COMPLETE RESTORATION WITHIN 2 WEEKS OF SUCCESSFUL PIPE PRESSURE TESTING AT ANY GIVEN LOCATION. TEST SHALL BE PERFORMED VALVE TO VALVE WITHIN ONE WEEK OF COMPLETING THAT SECTION. PRESSURE TESTING SHALL TAKE PLACE EVERY 2 WEEKS DURING CONSTRUCTION FOR ANY PIPE INSTALLED IN THAT PERIOD.

#### UTILITY CONTACTS:

OWNER	CONTACT	<u>PHONE</u>
BAY COUNTY TRAFFIC	BOB EDMUNDS	850-248-8760
CITY OF PANAMA CITY	CHRIS LIGHTFOOT	850-872-3191
KNOLOGY HOLDINGS	STEVE THOMAS	850-215-2138
COMCAST CABLE	JEFFERY SMITH	850-770-8056
SOUTHERN LIGHT	ANDRO BRAMBLETT	251-662-1170
GULF POWER	KENNY DOUGLAS	850-505-5567
AT&T	NANCY SPENCE	770-918-5424
AT&T DISTRIBUTION	DANNEY WATSON	334-850-7761
TECO GAS	ROLAND MOORE	850-914-6129

#### **EROSION AND SEDIMENT CONTROL NOTES:**

#### CONSTRUCTION:

- CONTRACTOR SHALL STAGE AND TIME CONSTRUCTION TO MINIMIZE THE SIZE OF EXPOSED SOIL AREAS AND THE TIME BETWEEN EXPOSING THE SOIL AREA AND FINISHING THE SOIL AREA.
- 2. AS SOON AS GRADING IS COMPLETE IN AN AREA, THE CONTRACTOR WILL STABILIZE THE SOIL. FOR LONG, NARROW AREAS, THE CONTRACTOR SHALL STABILIZE CONTINUOUSLY DURING GRADING OPERATIONS. ROUGH GRADED AREAS SHOULD BE STABILIZED WITH TEMPORARY EROSION CONTROL IF FINAL GRADING AND STABILIZATION WILL NOT BE PERFORMED WITHIN FIVE (5) DAYS. FAILURE TO STABILIZE EXPOSED SOIL AREAS IN A TIMELY MANNER AFTER GRADING MAY BE CONSIDERED A VIOLATION OF CHAPTERS 17-3, 17-12, AND/OR 17/25, FLORIDA ADMINISTRATIVE CODE, BY THE FLORIDA DEPARTMENT OF ENVIRONMENTAL PROTECTION (FDEP) AND SUBJECT TO CORRECTIVE ACTION, PURSUANT TO SECTION 403.121-403.161 FLORIDA STATUTES.
- 3. IT SHALL BE THE RESPONSIBILITY OF THE CONTRACTOR PERFORMING A TASK TO PROVIDE EROSION CONTROL UNLESS ANOTHER PARTY HAS BEEN PREVIOUSLY SPECIFIED AS RESPONSIBLE FOR THE EROSION CONTROL ASSOCIATED WITH THAT TASK. IN THE EVENT ANOTHER PARTY IS RESPONSIBLE FOR EROSION CONTROL, THE CONTRACTOR SHALL STILL BE RESPONSIBLE FOR COORDINATION WITH THE PARTY RESPONSIBLE. IN THE EVENT THAT DAMAGE TO THE CONSTRUCTED ITEM RESULTS ARE DUE TO LACK OF EROSION CONTROL, THE CONTRACTOR SHALL REPAIR OR REPLACE THE ITEM AT NO CHARGE TO THE OWNER.
- 4. TEMPORARY EROSION CONTROL SHALL CONSIST OF TEMPORARY GRASS, TEMPORARY MULCH, TEMPORARY SOD, ARTIFICIAL COVERINGS, BALED HAY OR STRAW, SILT FENCES, AND TURBIDITY BARRIERS. TEMPORARY EROSION CONTROL SHALL BE IN ACCORDANCE WITH SECTION 104 OF THE FLORIDA DEPARTMENT OF TRANSPORTATION (FDOT) STANDARD SPECIFICATIONS.
- 5. PERMANENT EROSION CONTROL SHALL CONSIST OF SEED, SEED AND MULCH, HYDRO-SEEDING, SOD, AND/OR ARTIFICIAL COVERINGS. PERMANENT EROSION CONTROL SHALL BE IN ACCORDANCE WITH SECTIONS 570 AND 575 OF THE FDOT STANDARD SPECIFICATIONS. SEED OR GRASS TYPE SHALL MATCH EXISTING OR BE AS SPECIFIED BY OWNER UNLESS NOTED OTHERWISE.
- 6. GRASS BY SEEDING SHALL BE IN ACCORDANCE WITH SECTIONS 104, 570, 981, 982, AND 983 OF FDOT STANDARD SPECIFICATIONS. THIS SHALL BE USED ONLY IN AREAS SUBJECT TO LIGHT EROSION SUCH AS FLAT AREAS.
- 7. GRASS BY HYDRO-SEEDING SHALL BE IN ACCORDANCE WITH SECTIONS 104, 570, 981, 982, AND 983 OF FDOT STANDARD SPECIFICATIONS. HYDRO-SEEDING MAY BE USED FOR FLAT AREAS AND SIDE SLOPES WHICH DO NOT EXCEED 2:1. DRAINAGE DITCHES OR LARGE SWALES MUST HAVE ADDITIONAL PROTECTION BESIDES HYDRO-SEEDING.
- 8. GRASS AND MULCH SHALL BE IN ACCORDANCE WITH SECTIONS 104, 570, 981, 982, AND 983 OF FDOT STANDARD SPECIFICATIONS. GRASS AND MULCH MAY BE USED IN ALL AREAS EXCEPT LARGE SWALES OR DITCHES. MULCH SHALL BE ANCHORED IN ACCORDANCE WITH SECTION 570. SOLID SOD SHALL BE IN ACCORDANCE WITH SECTIONS 104, 575, 981, 982, AND 983 OF FDOT STANDARD SPECIFICATIONS. SOD MAY BE USED IN ALL AREAS FOR SIDE SLOPES LESS THAN 2:1. SOD SHOULD NOT BE USED ON SLOPES GREATER THAN 1:2 (V:H). EROSION CONTROL BLANKETS WITH GRASSING OR OTHER SLOPE STABILIZATION TECHNIQUES SHOULD BE USED ON SLOPES GREATER THAN 1:2. SOD SHALL BE STAGGERED SO AS TO AVOID A CONTINUOUS SEAM. IN AREAS WITH SLOPES 3:1 OR STEEPER, EACH PIECE OF SOD SHALL BE PEGGED WITH SOD PEGS. IN DIFFICULT SOIL CONDITIONS WITH STEEP SLOPES, IT MAY NECESSARY TO COVER SOD WITH ARTIFICIAL COVERINGS SUCH AS JUTE MESH UNTIL SOD BECOMES ESTABLISHED.
- 9. TEMPORARY EROSION CONTROL BY ARTIFICIAL COVERINGS SHALL CONSIST OF STRAW BLANKETS, COCONUT FIBER BLANKETS, POLYESTER BLANKETS, JUTE MESH, AND DRAINAGE FABRICS. MATERIALS SHALL BE INSTALLED IN ACCORDANCE WITH MANUFACTURER'S RECOMMENDATIONS. SEEDING SHALL BE INCLUDED IF MATERIAL REQUIRES VEGETATION TO FUNCTION PROPERLY.
- 10. THE CONTRACTOR IS TO PROVIDE EROSION CONTROL/ SEDIMENTATION BARRIER (HAY BALES, SILT FENCE, TURBIDITY BARRIER, OR AS SPECIFIED IN THE CONSTRUCTION DRAWINGS) TO PREVENT SILTATION OF ADJACENT PROPERTY, STREETS, STORM SEWERS, WATERWAYS, AND WETLAND OR JURISDICTIONAL AREAS. IF, IN THE OPINION OF THE ENGINEER, AND/OR REGULATORY AUTHORITIES, EXCESSIVE QUANTITIES OF MATERIAL ARE TRANSPORTED OFFSITE BY EROSION OR STORM WATER RUNOFF, THE CONTRACTOR SHALL IMPROVE CONDITIONS TO THE SATISFACTION OF THE ENGINEER AND/OR AUTHORITIES IN NO CASE SHALL CONSTRUCTION COMMENCE PRIOR TO INSTALLATION OF EROSION CONTROL/SEDIMENTATION BARRIER.
- 11. CONTRACTOR SHALL PLACE STRAW, MULCH, OR OTHER SUITABLE MATERIAL ON GROUND IN AREAS WHERE CONSTRUCTION-RELATED TRAFFIC IS TO ENTER AND EXIT SITE.
- 12. IF WIND EROSION BECOMES SIGNIFICANT DURING CONSTRUCTION, THE CONTRACTOR SHALL STABILIZE THE AREA USING SPRINKLING IRRIGATION OR OTHER ACCEPTABLE METHODS.

#### MAINTENANCE:

- 13. THE CONTRACTOR SHALL PROVIDE ROUTINE MAINTENANCE OF PERMANENT AND TEMPORARY EROSION CONTROL FEATURES. UNTIL THE PROJECT IS COMPLETED AND ACCEPTED. THEN MAINTENANCE SHALL BE IN ACCORDANCE WITH SECTION 104 OF THE FLORIDA DEPARTMENT OF TRANSPORTATION (FDOT) STANDARD SPECIFICATIONS OR BAY COUNTY SPECIFICATIONS.
- 14. SILT FENCES AND TURBIDITY BARRIERS SHALL BE CHECKED DAILY FOR EFFECTIVENESS, BREACHES, AND ROUTINE MAINTENANCE.

#### PAVING, GRADING, AND EARTH WORK NOTES:

#### CONSTRUCTION:

- ALL AREAS DISTURBED BY CONSTRUCTION ACTIVITIES SHALL BE SEEDED, MULCHED, SODDED, STABILIZED, OR PLANTED WITH OTHER APPROVED LANDSCAPE MATERIAL, WITHIN FIVE (5) DAYS AFTER CONSTRUCTION.
- 2. ALL WASTE MATERIAL SHALL BE DISPOSED OF OFFSITE IN ACCORDANCE WITH APPLICABLE REGULATIONS.
- 3. PROPOSED SPOT ELEVATIONS REPRESENT PAVEMENT OR GROUND SURFACE GRADE UNLESS OTHERWISE NOTED ON DRAWINGS.
- 4. CONTRACTOR TO PROVIDE 1/2" TO 1" BITUMINOUS EXPANSION JOINT MATERIAL WITH SEALER AT ABUTMENT OF CONCRETE AND OTHER MATERIALS (BUILDINGS, OTHER POURED CONCRETE, ETC.) EXCEPT ASPHALT.
- 5. CONTRACTOR SHALL TRIM, TACK AND MATCH EXISTING PAVEMENT AT LOCATIONS WHERE NEW PAVEMENT ABUTS.
- 6. TESTING SHALL BE IN GENERAL CONFORMANCE WITH THE FDOT SPECIFICATIONS FOR ROAD AND BRIDGE CONSTRUCTION, LATEST EDITION. SELECTION AND CONTRACTING WITH THE TESTING FIRMS SHALL BE THE RESPONSIBILITY OF THE CONTRACTOR. IT SHALL BE THE RESPONSIBILITY OF THE CONTRACTOR TO COORDINATE AND SCHEDULE ALL TESTS, AND PROVIDE TO THE ENGINEER OF RECORD.
- 7. ALL POTHOLES WITHIN THE LIMITS OF PROJECT SHALL BE FILLED WITH ASPHALT AND COMPACTED PRIOR TO RESURFACING.
- 8. TOP SOIL SHALL BE PLACED IN AREAS WHERE SOD IS PROPOSED, PRIOR TO INSTALLATION OF SOD.

#### SIGNING AND MARKING NOTES:

- FOR SIGN DETAILS, USE THE MANUAL OF UNIFORM TRAFFIC CONTROL DEVICES PUBLISHED BY THE US DEPARTMENT OF TRANSPORTATION, FEDERAL HIGHWAY ADMINISTRATION, 2009.
- 2. ALL SIGNAGE AND WHEEL STOPS SHALL BE REMOVED AND STOCKPILED ON SITE. CONTRACTOR SHALL COORDINATE STOCKPILE LOCATION WITH PROJECT ADMINISTRATOR.
- 3. THE SIGN LOCATIONS ARE APPROXIMATE AND MAY REQUIRE FIELD ADJUSTMENT AS DIRECTED BY THE PROJECT ADMINISTRATOR.
- 4. SIGNING AND PAVEMENT MARKINGS SHALL BE PLACED IN ACCORDANCE WITH CURRENT MUTCD, AMERICANS WITH DISABILITIES ACT, FDOT DESIGN STANDARDS (CURRENT EDITION), AND THE PLANS.
- 5. THE PAVEMENT MARKINGS AT ALL EXISTING/PROPOSED INTERFACE LOCATIONS SHALL MATCH IN TERMS OF ALIGNMENT AND COLOR.
- 6. ALL FINAL PROPOSED STRIPING AND MESSAGES SHALL BE THERMOPLASTIC. TEMPORARY STRIPING SHALL BE PAINT.

FLORIDA
ARCHITECTS
LICENSE #AA0002730
648 Florida Avenue
Panama City, Fl. 32401
P 850/257-5400

JONATHAN SKLARSKI FL. P.E. 67361

Principal in Charge

Joseph J. Sorci

Project Number:
4166-15
Date Issued:
5-4-2017
Drawn By:
M.W.
Checked By:

Revisions:
BID No.
ITB#8-2016/2017

J.S.



GULF COAST STATE COLLEGE CAMPUS IMPROVEMENTS



JONATHAN SKLARSKI FL. P.E. 67361

Joseph J. Sorci
Project Number:
4166-15
Date Issued:
5-4-2017
Drawn By:
M.W.

Checked By:
J.S.
Revisions:
BID No.

ITB#8-2016/2017

Dewberry
PREBLE-RISH


GULF COAST STATE COLLEGE CAMPUS IMPROVEMENTS


OVERALL SITE PLAN - AERIAL


CONSTRUCTION DOCUMENTS


Sheet Number


( IN FEET )

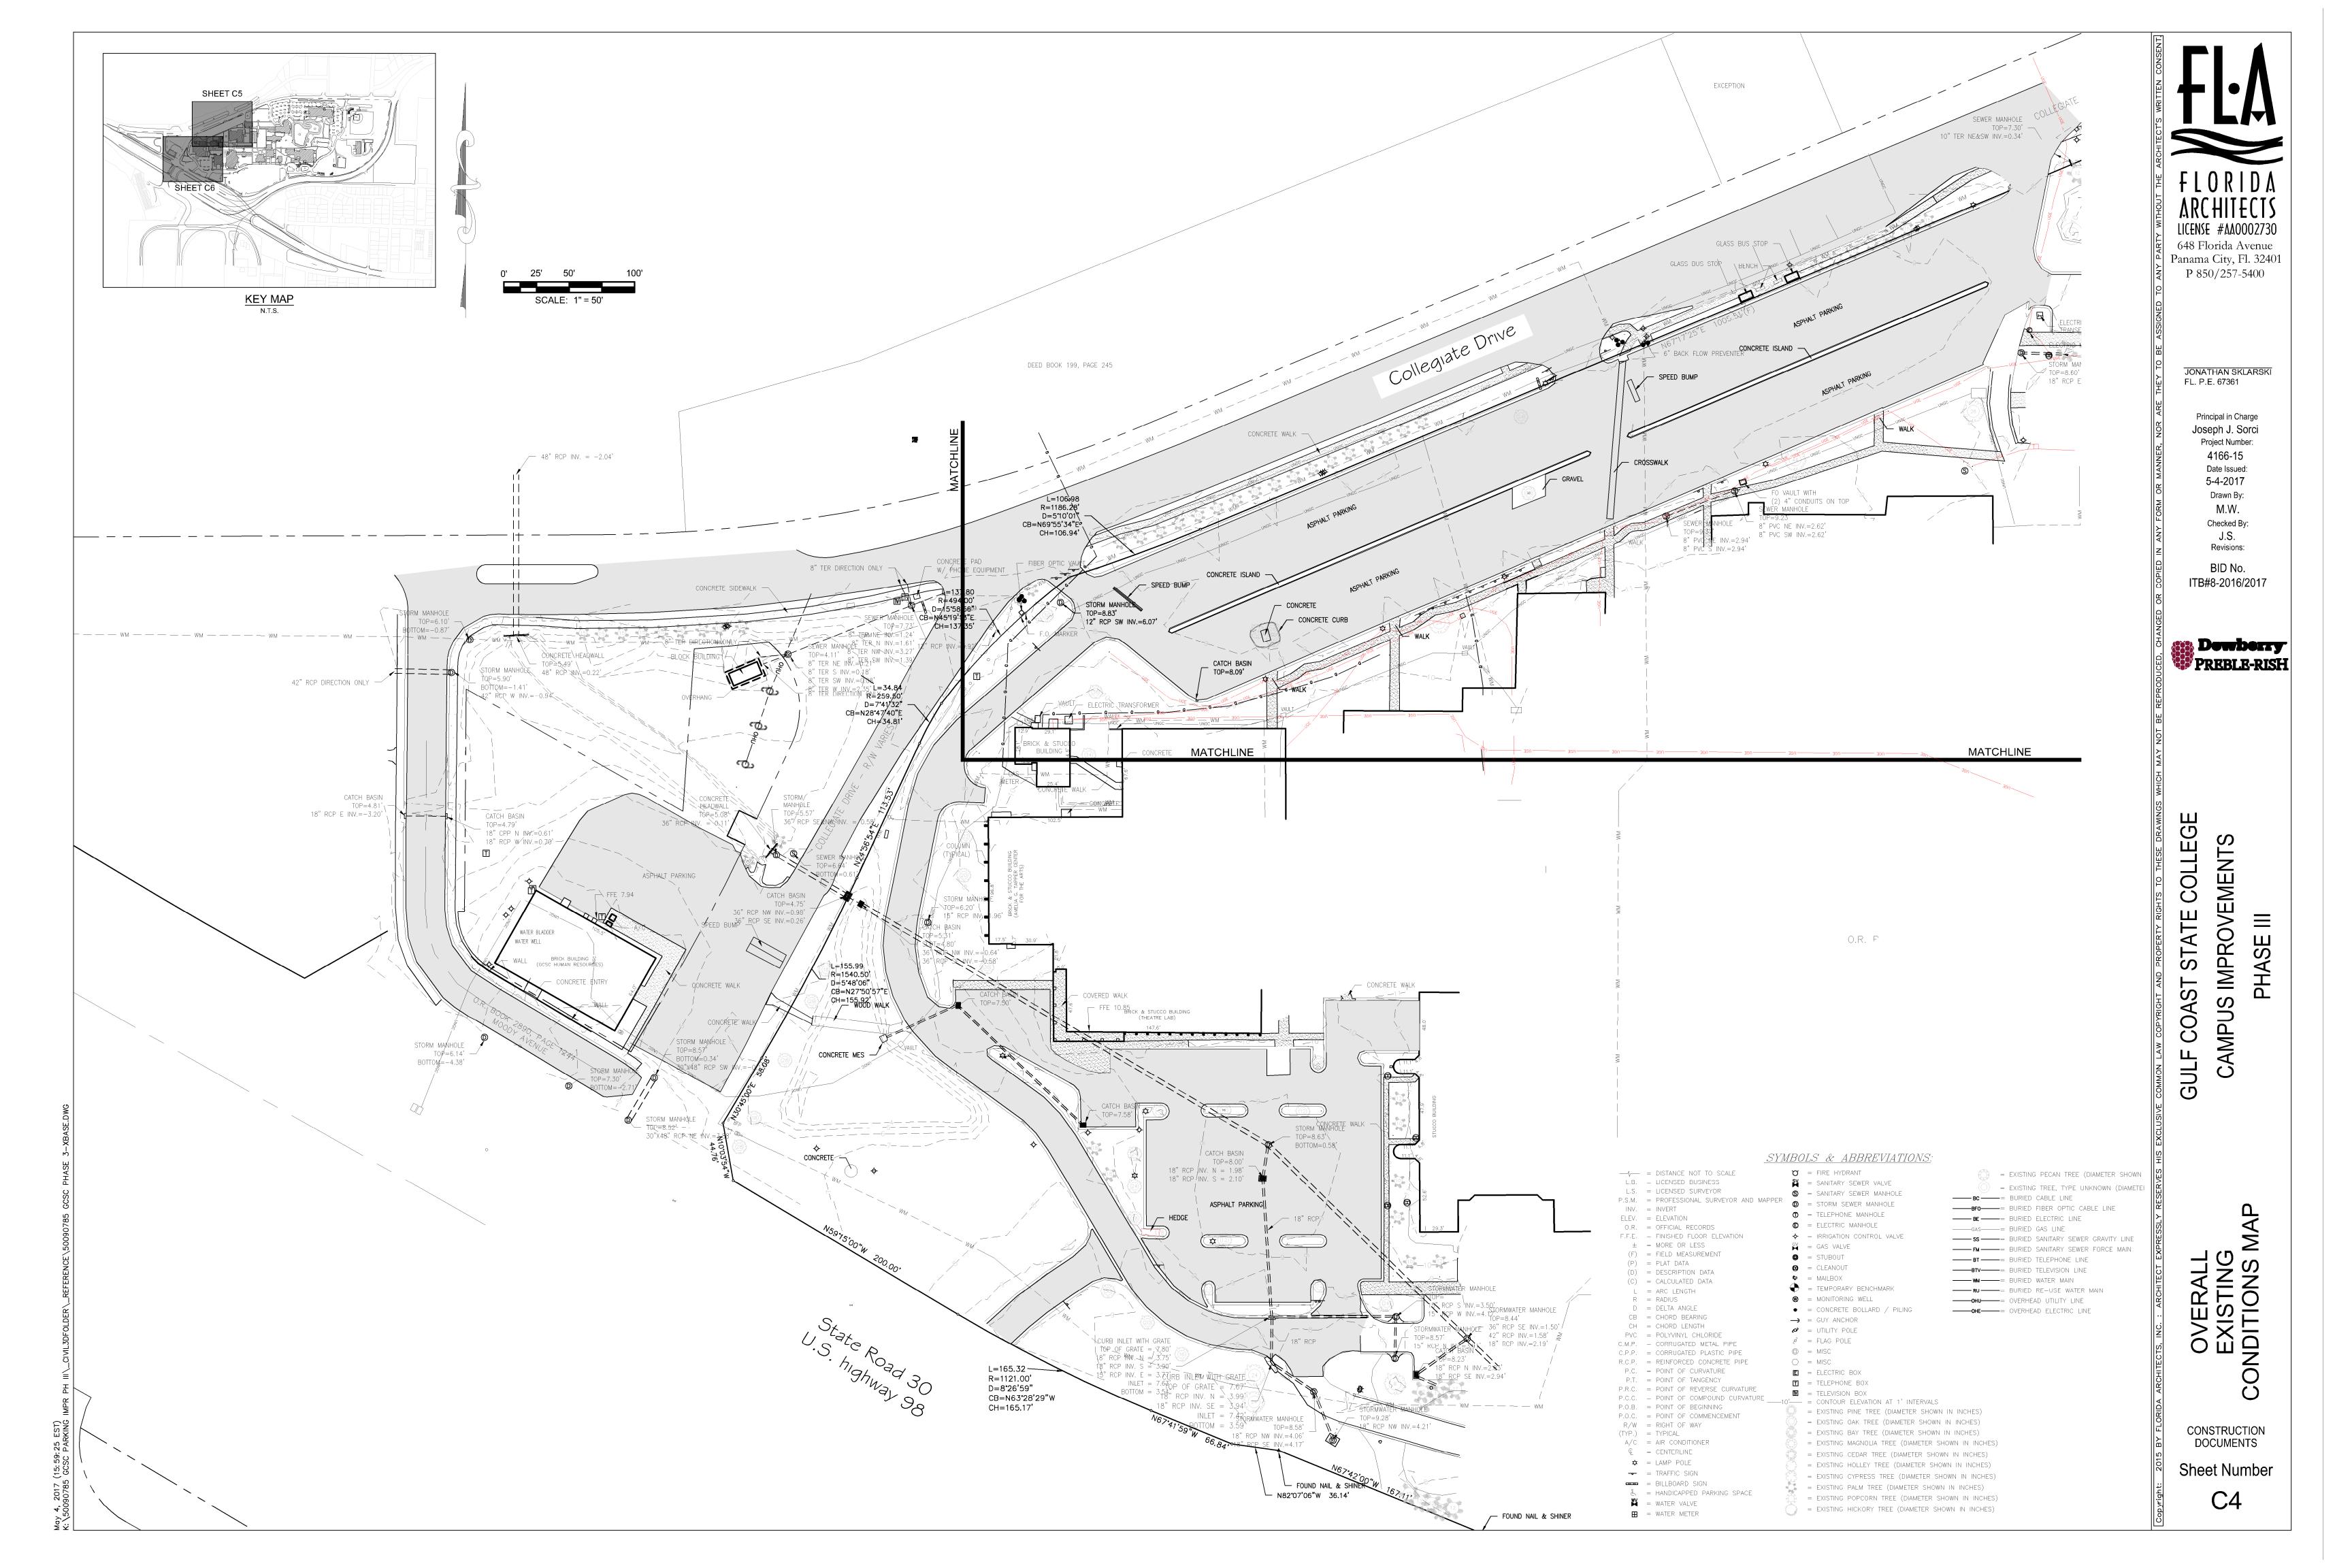


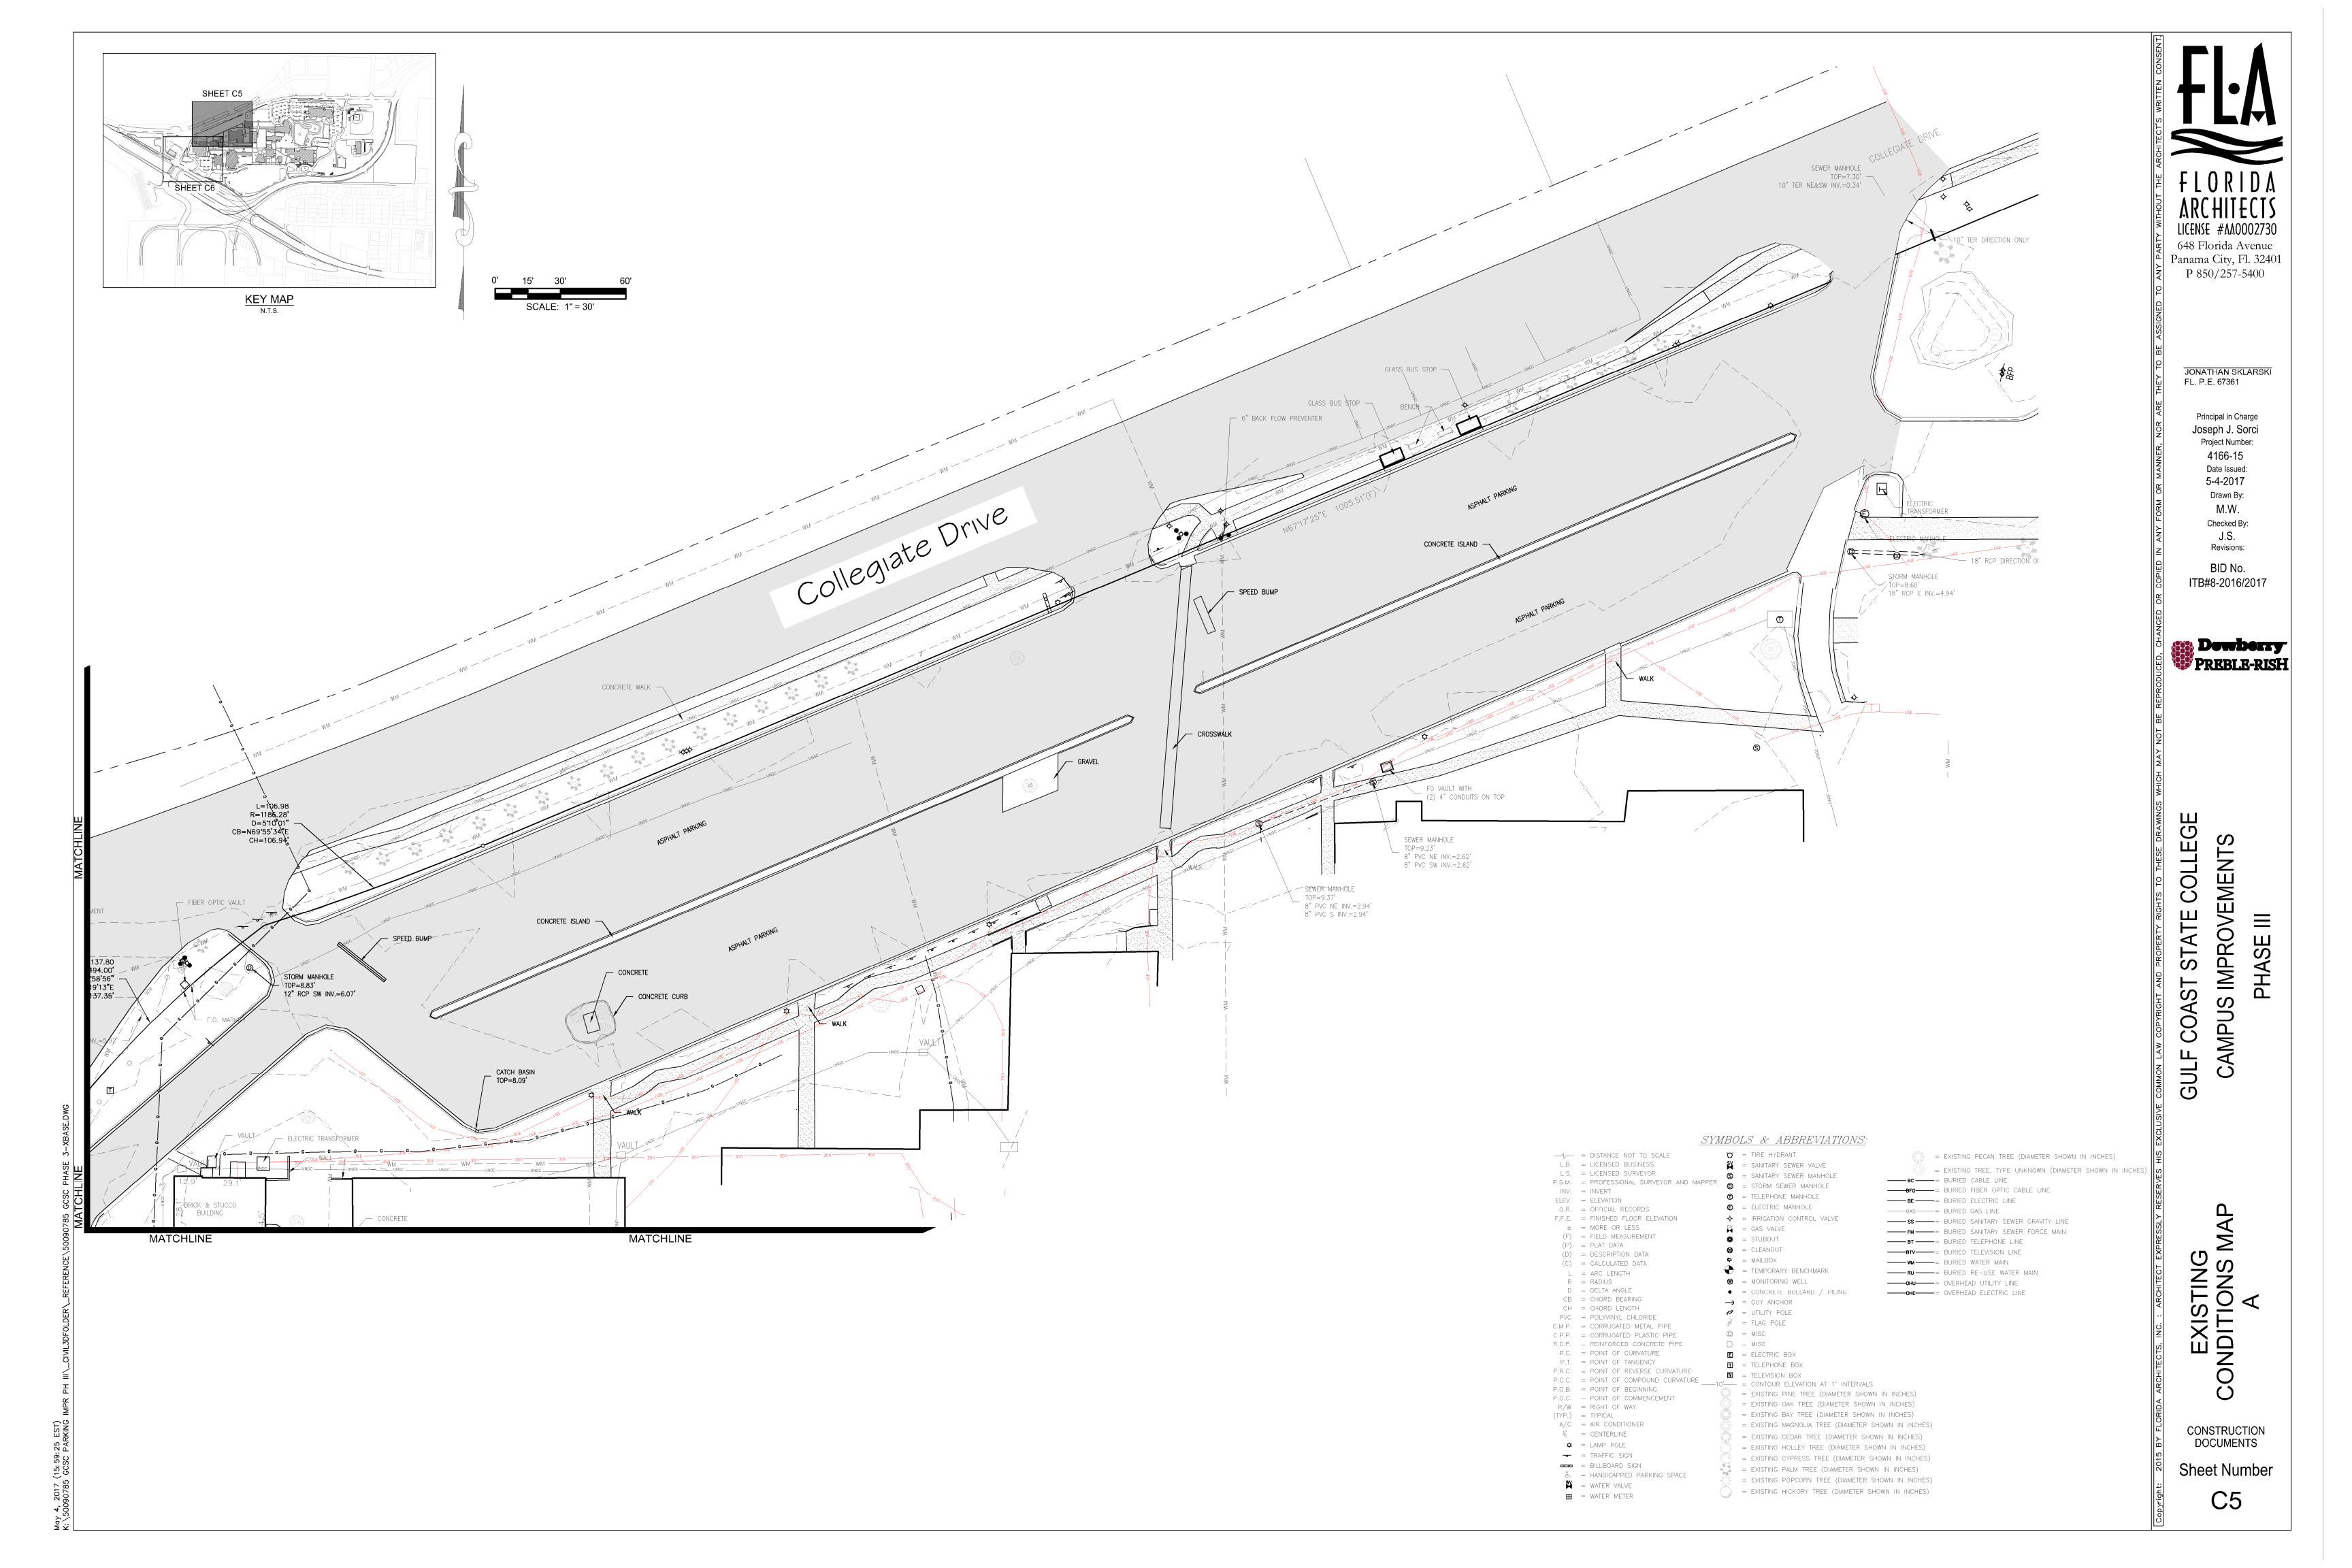


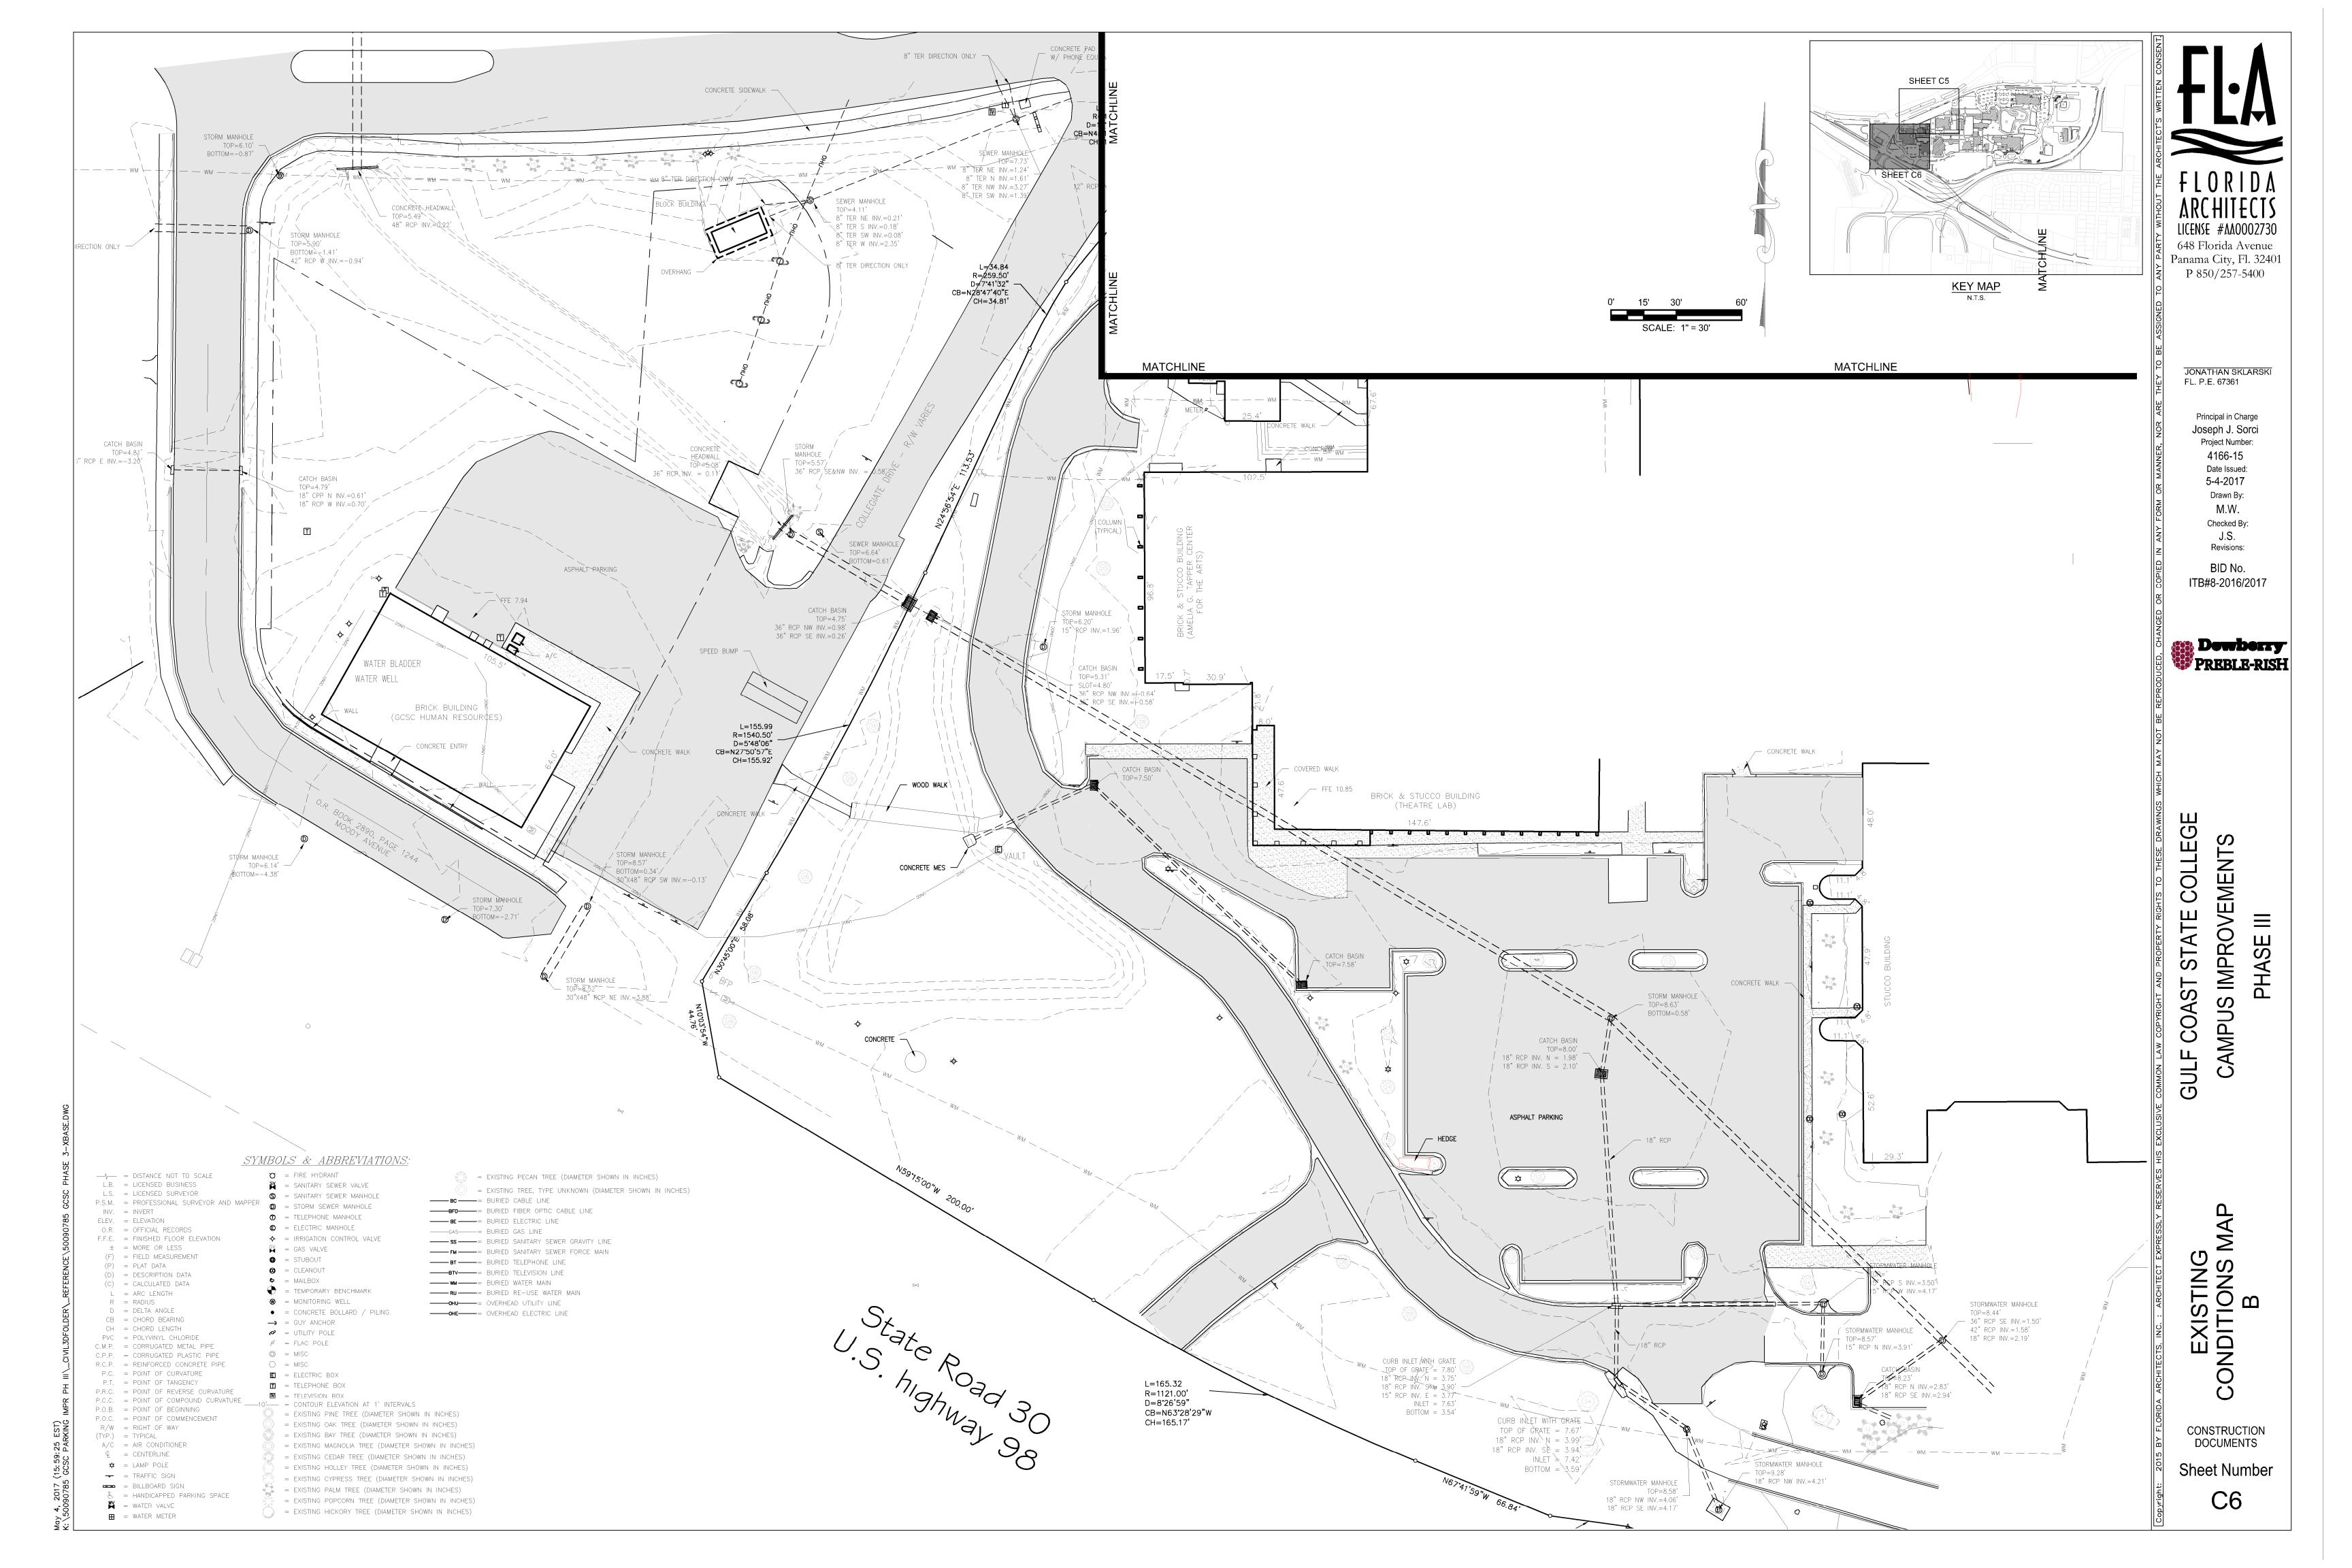

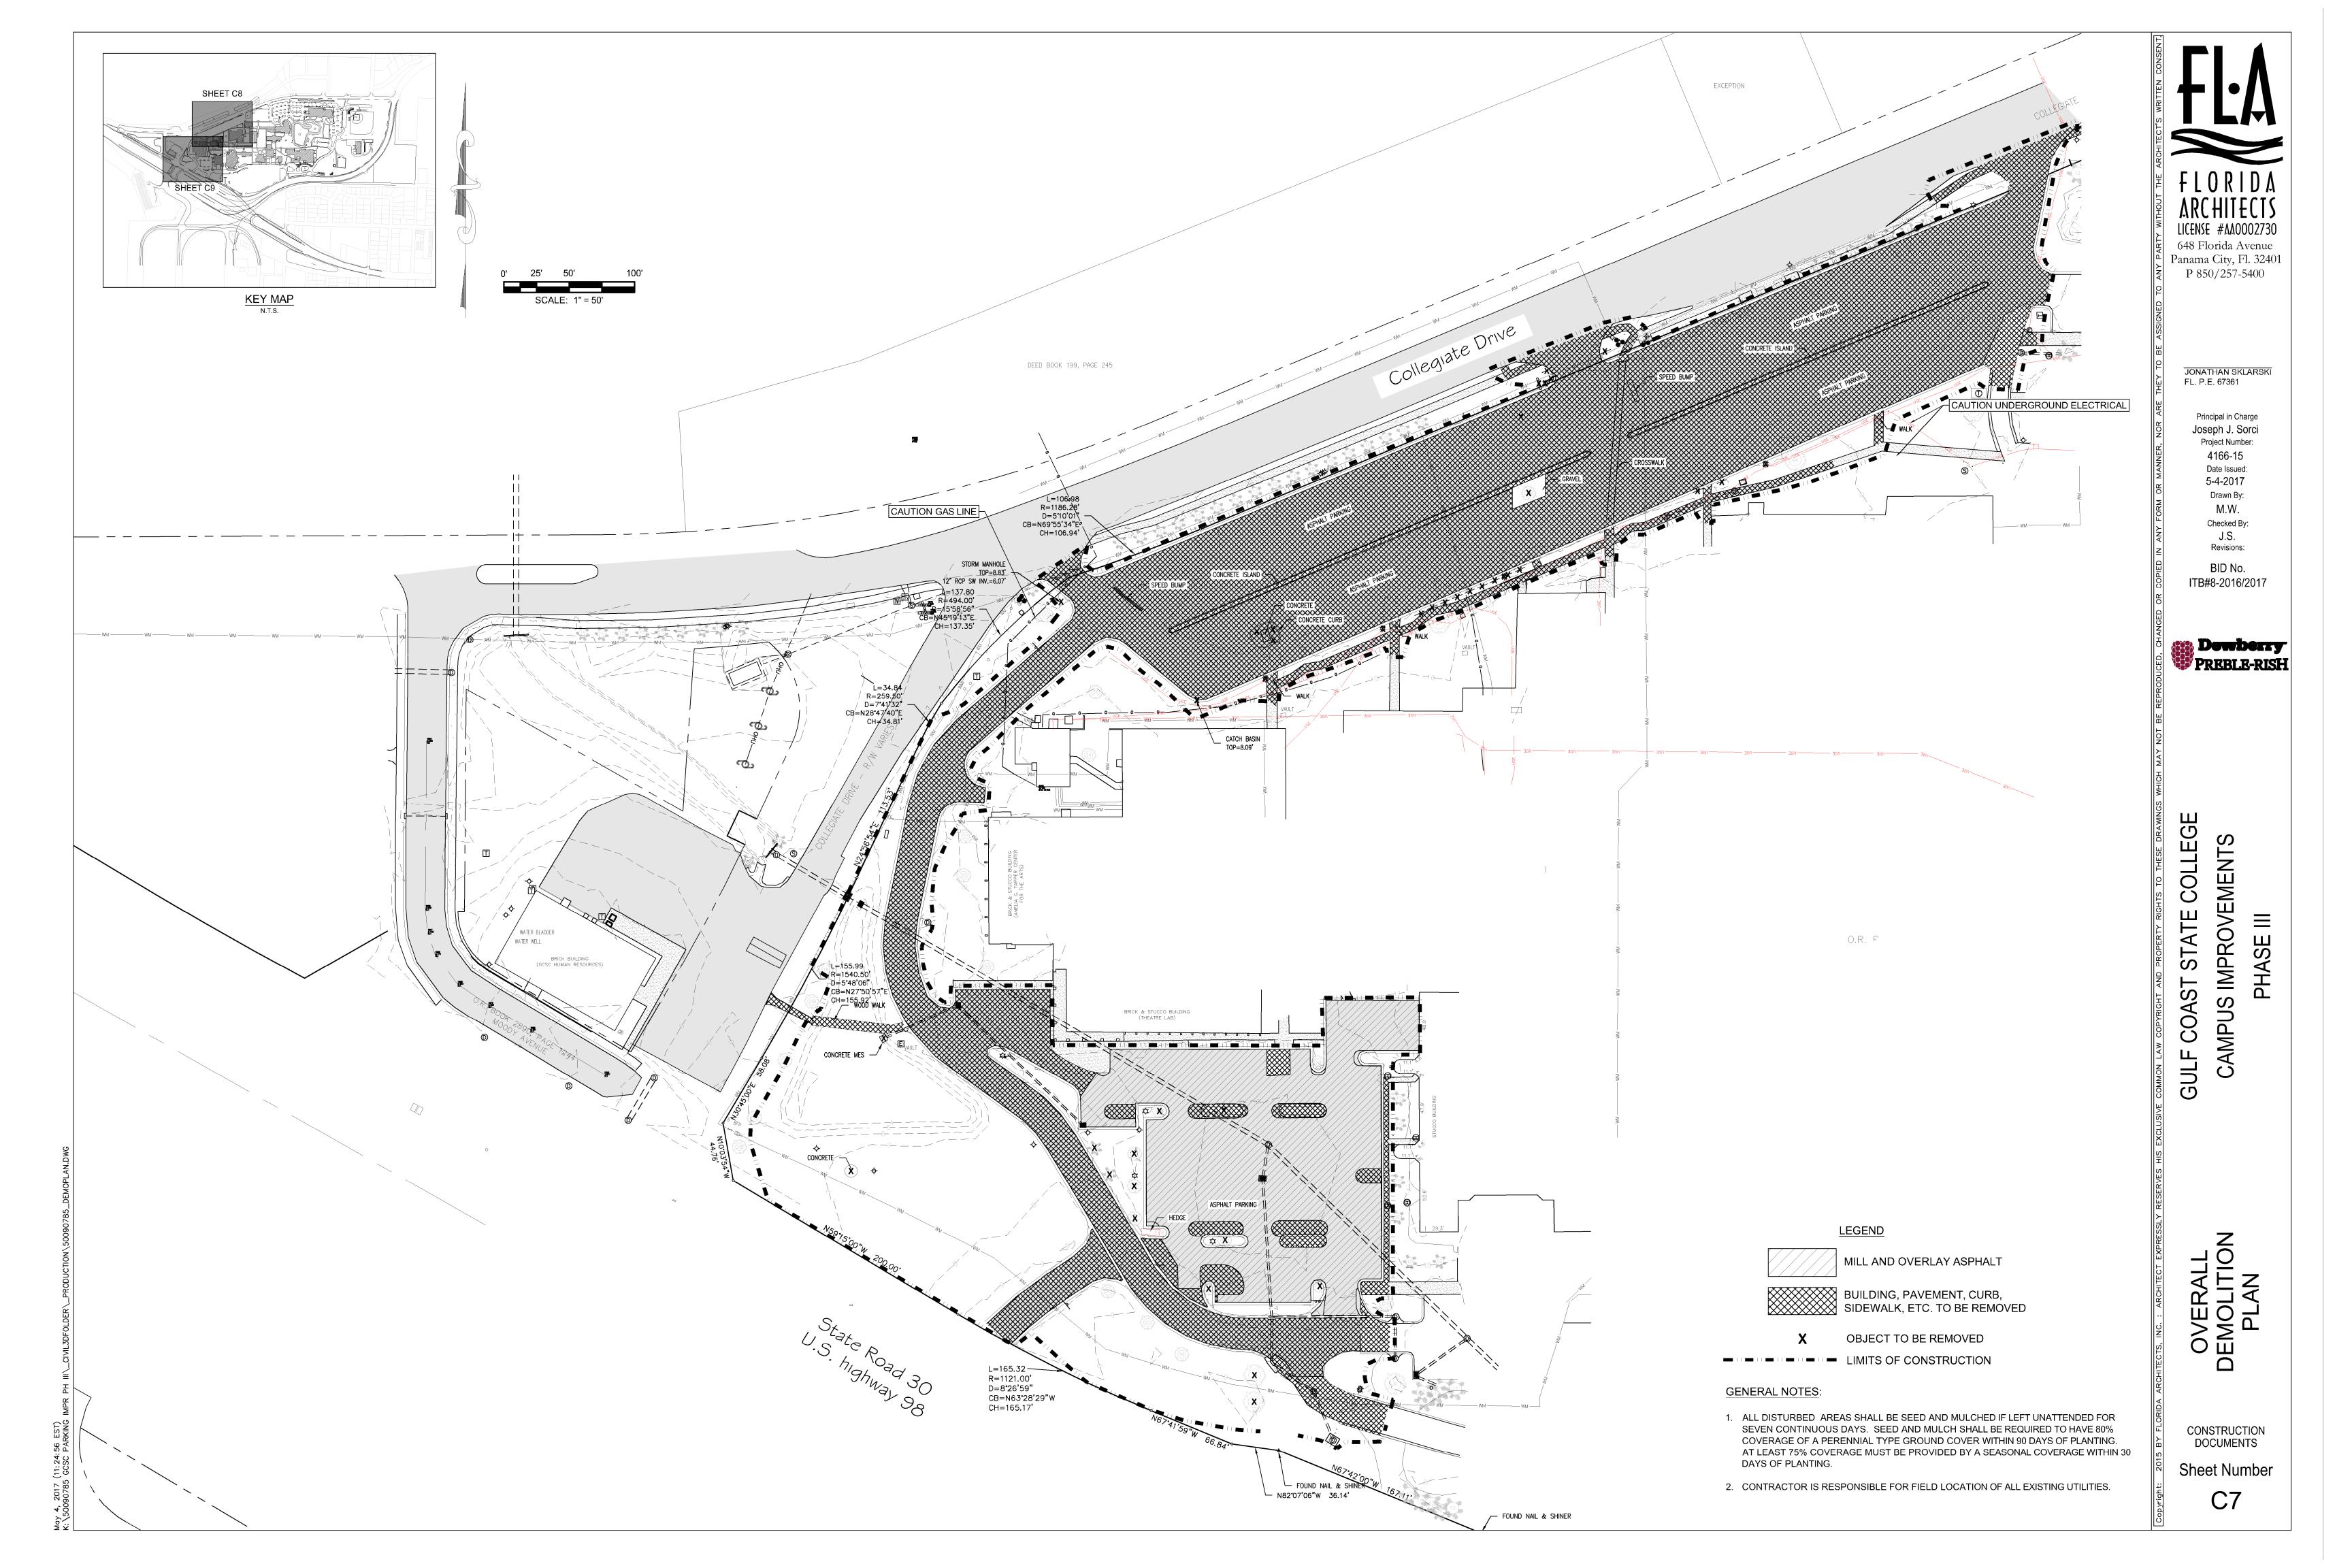

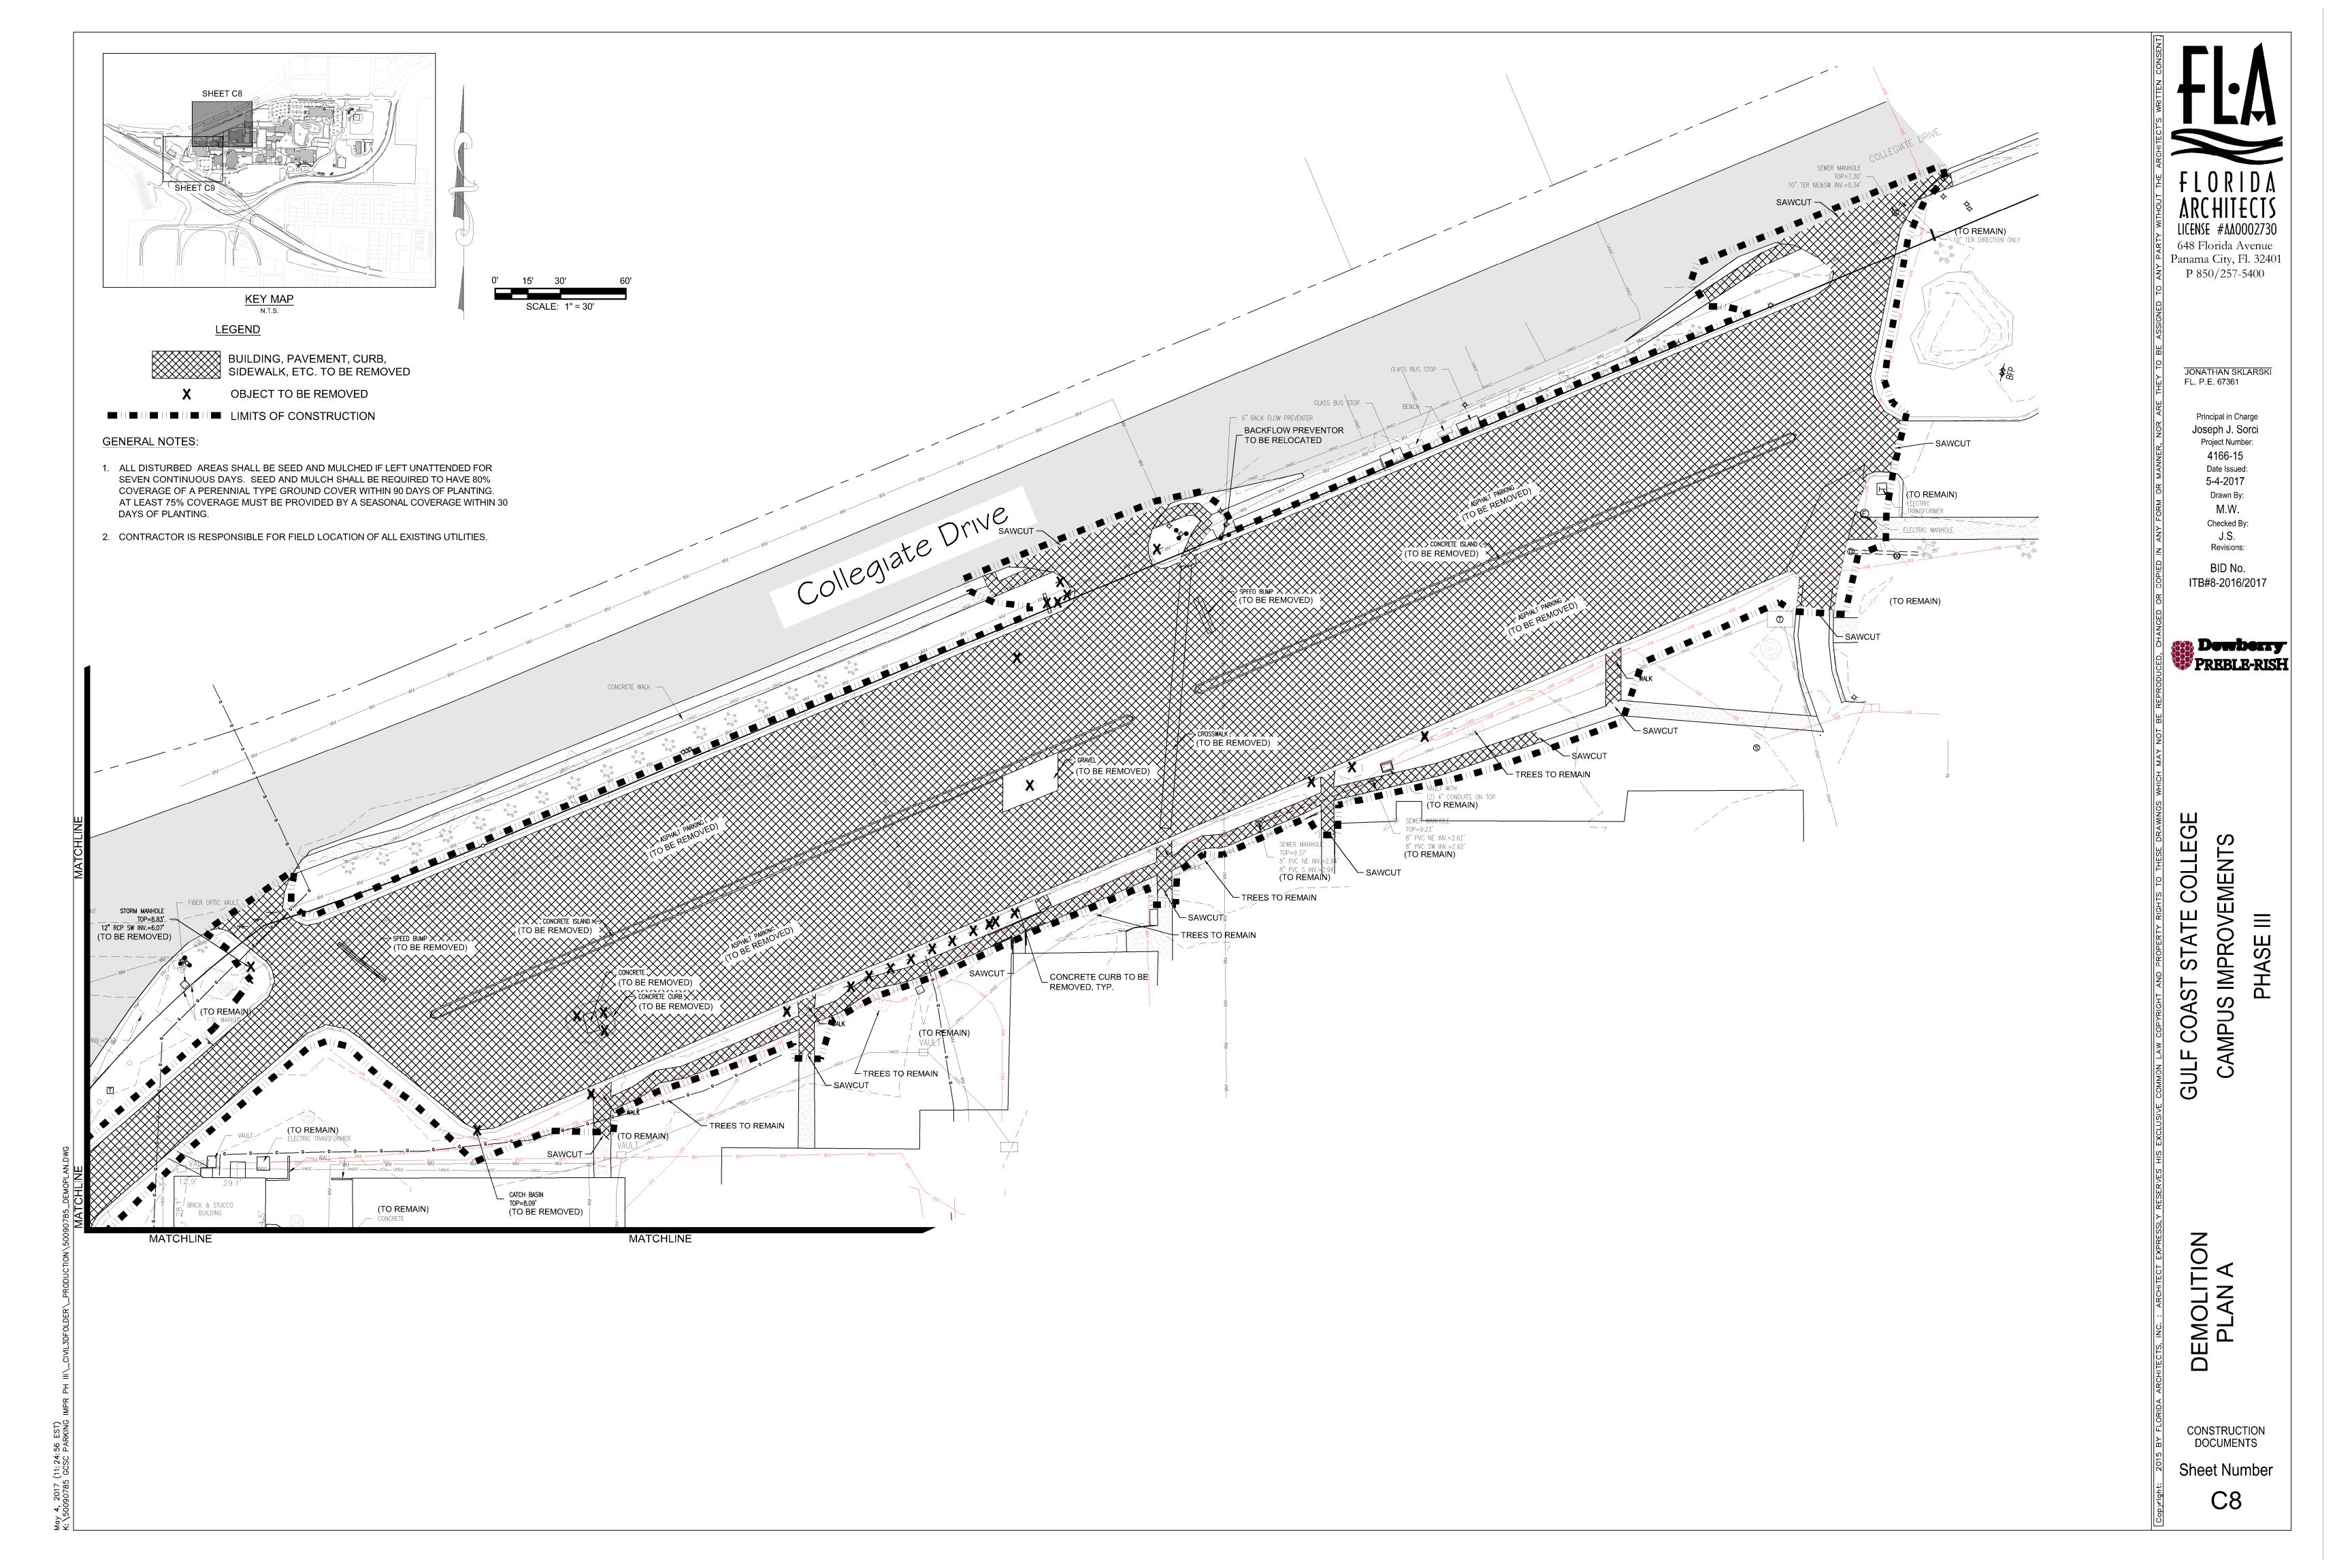

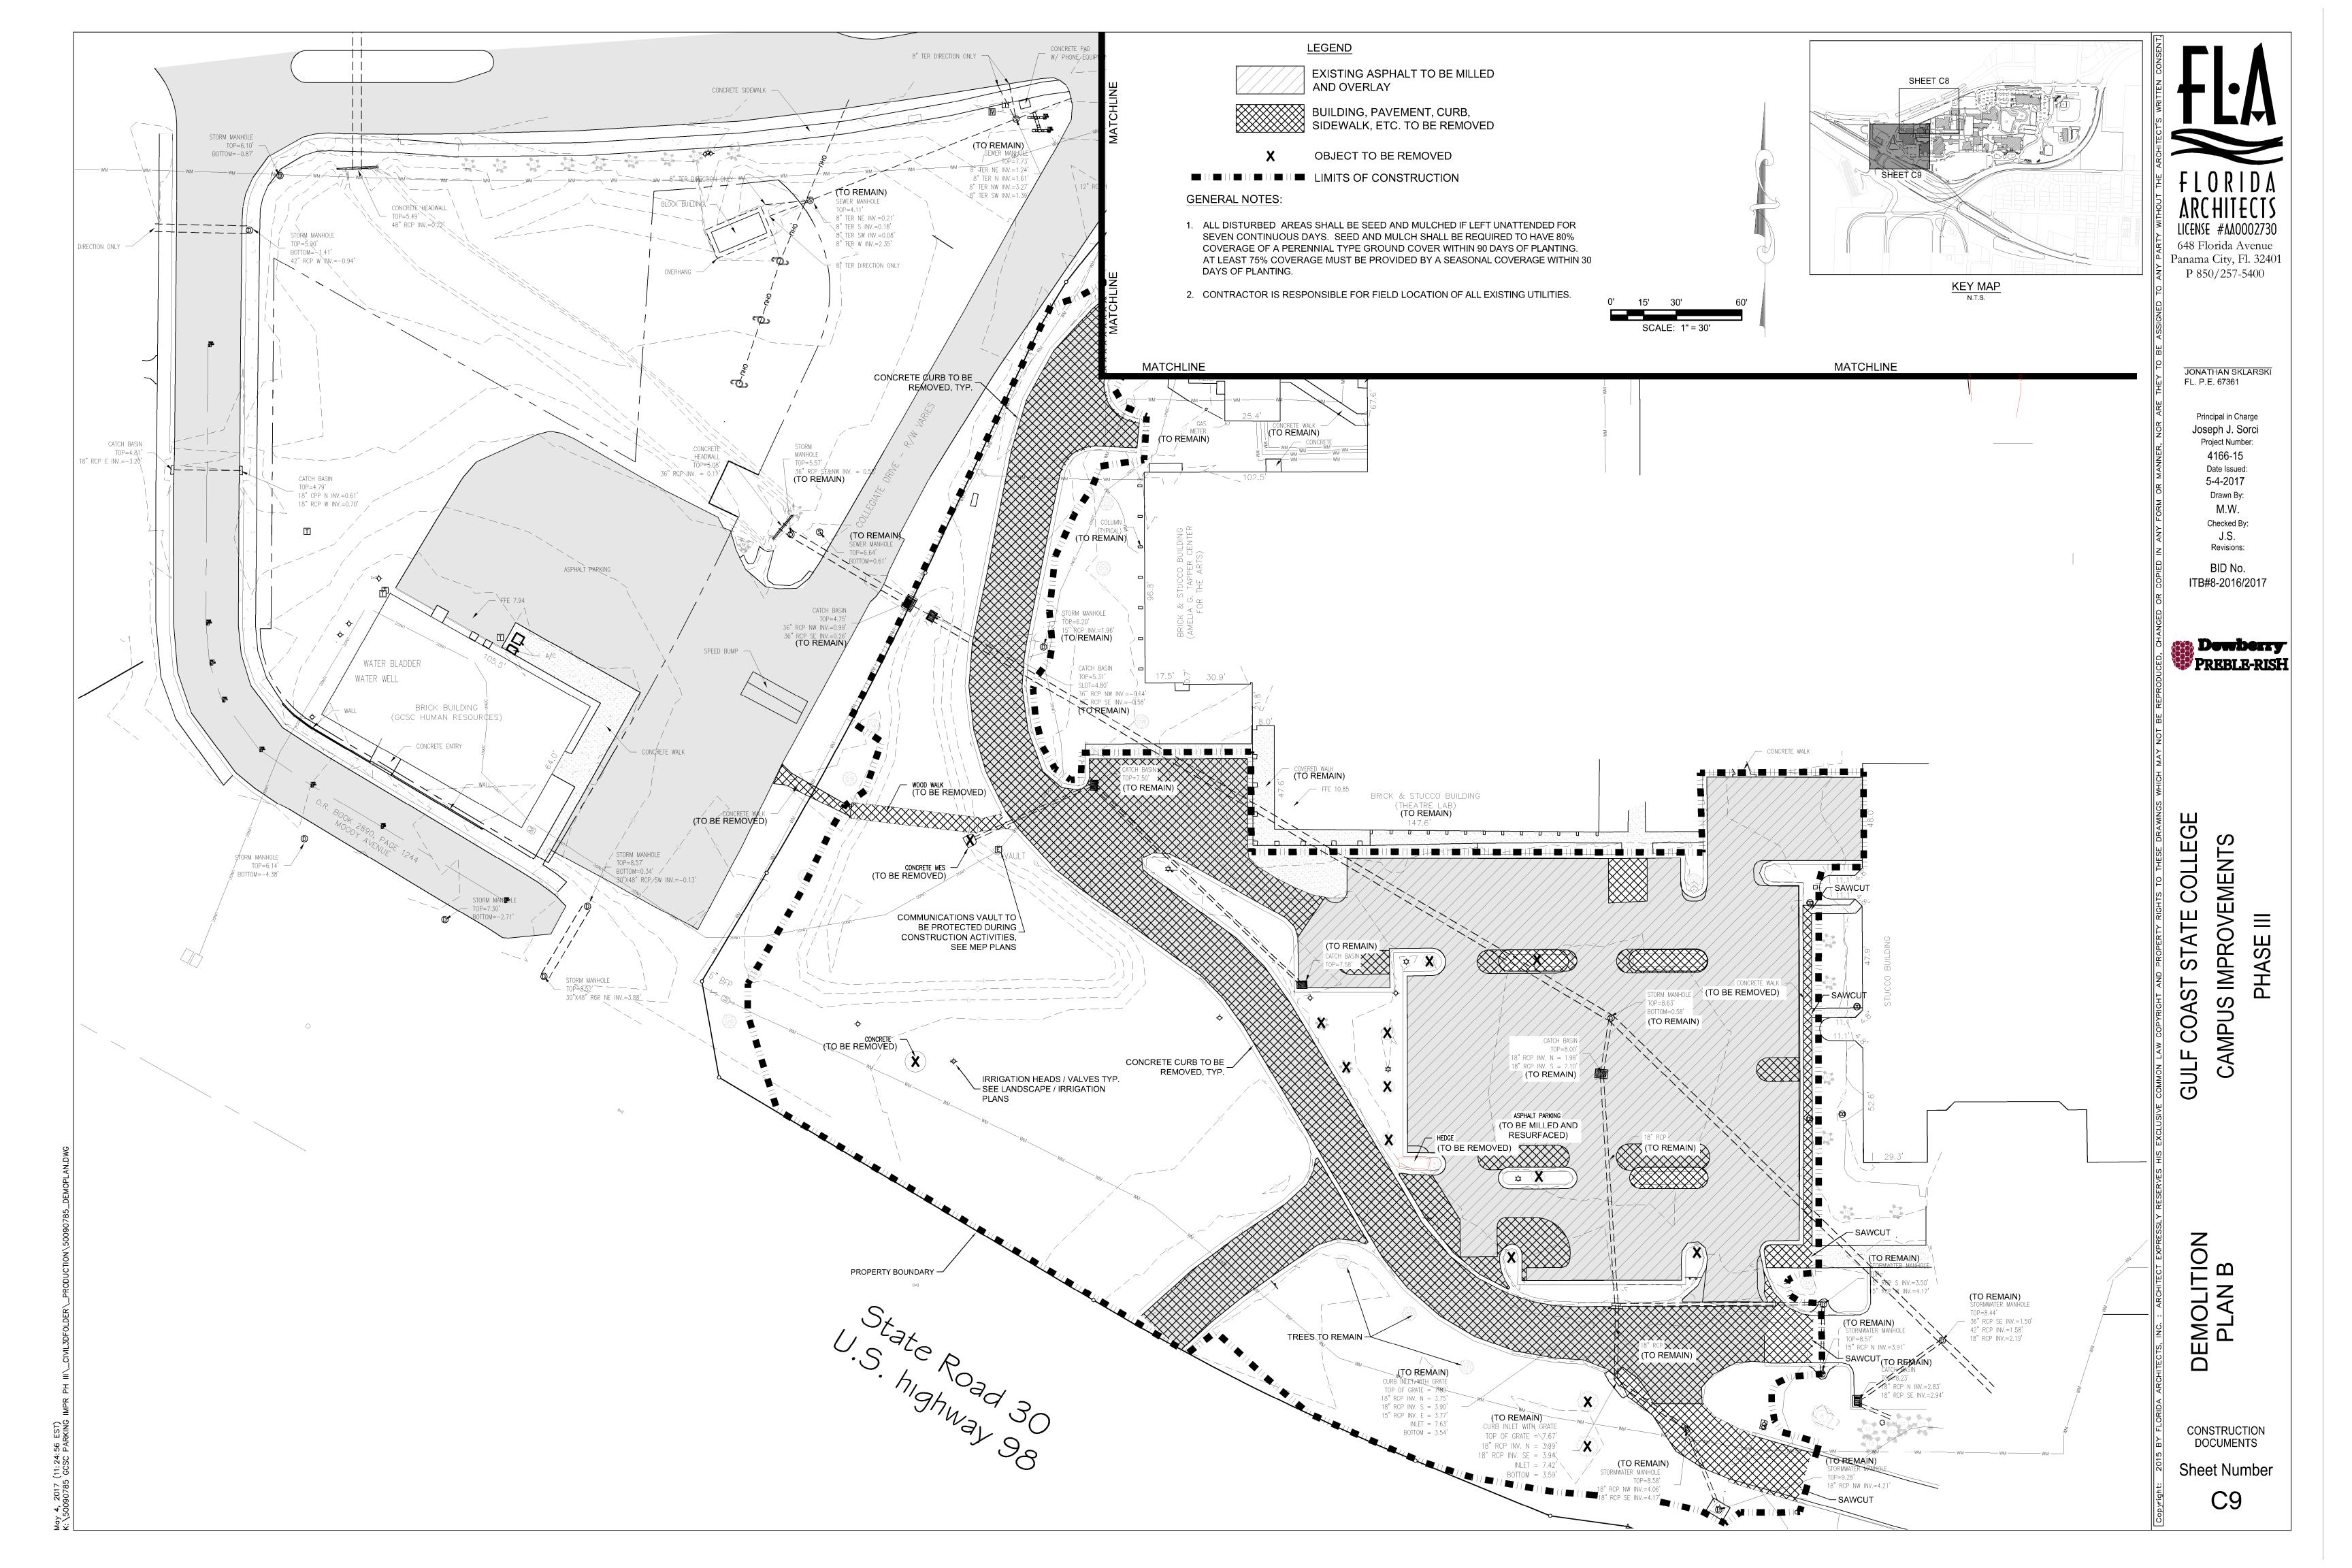

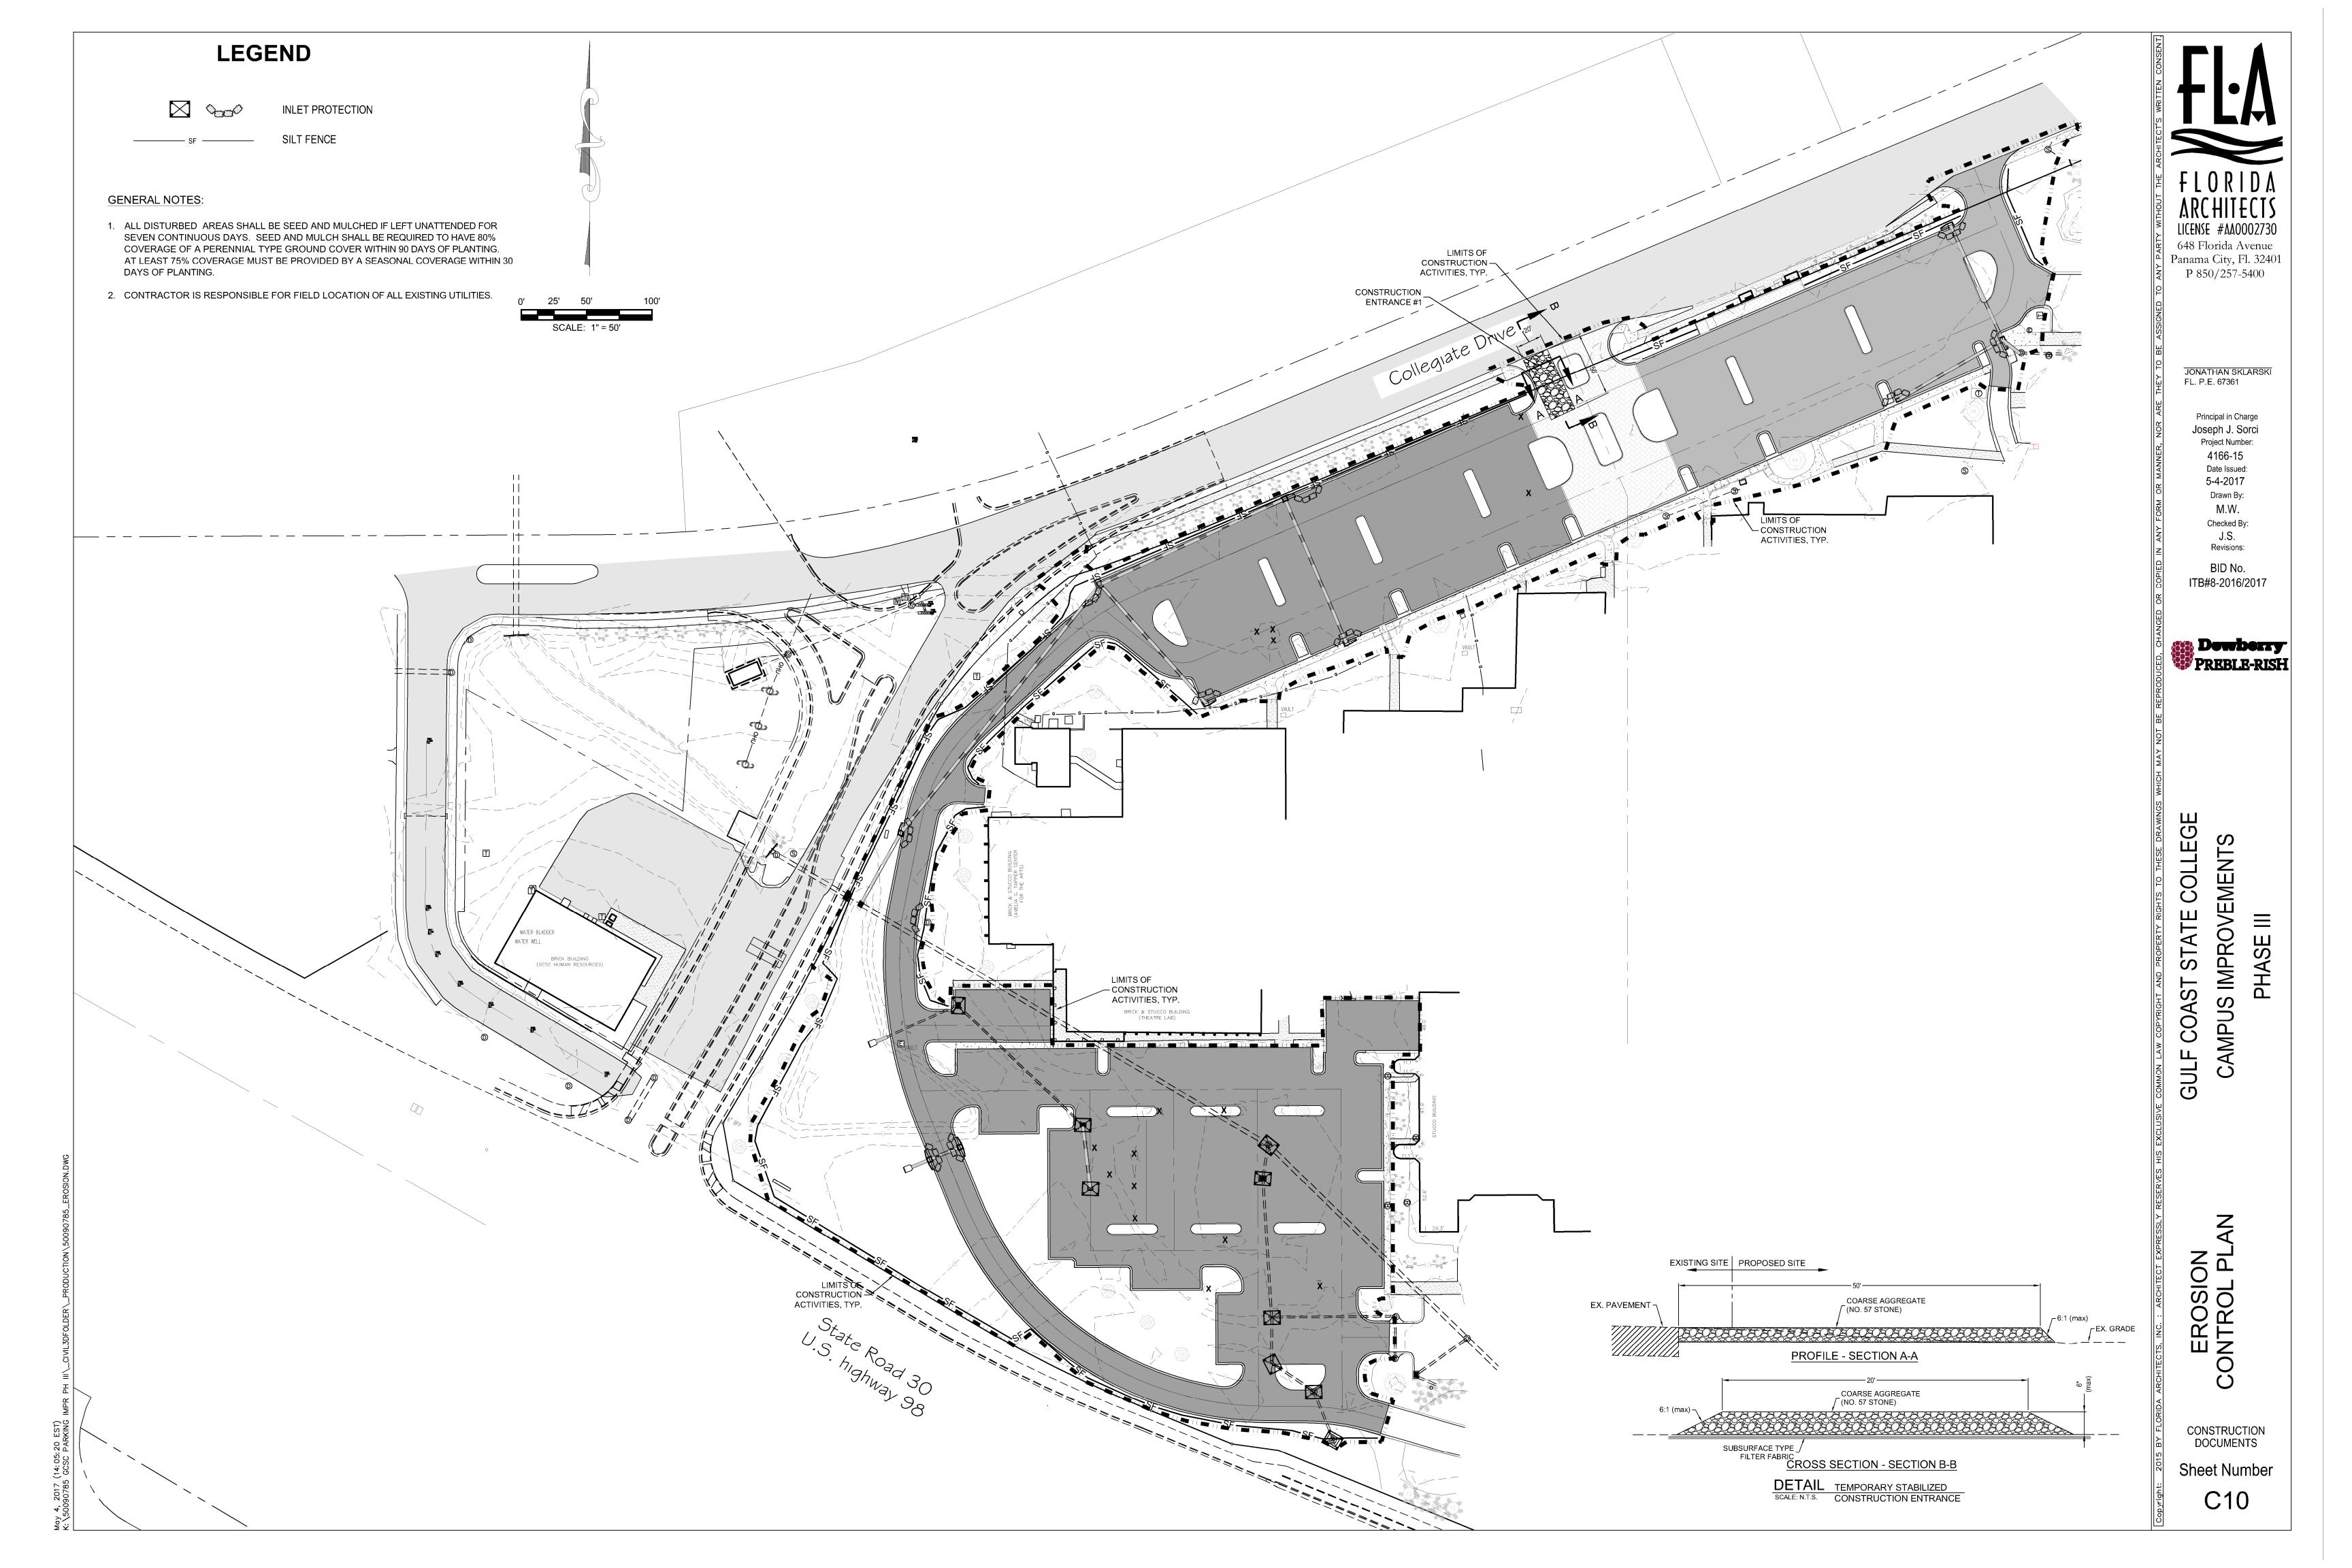

B. SEQUENCE OF MAJOR SOIL DISTURBING ACTIVITIES:

THE FOLLOWING SEQUENCE OF MAJOR ACTIVITIES SHALL BE FOLLOWED UNLESS THE CONTRACTOR CAN PROPOSE AN ALTERNATIVE THAT IS EQUAL OR BETTER AT CONTROLLING EROSION AND SEDIMENT AND IS APPROVED BY THE ENGINEER. THE DETAILED SEQUENCE FOR THE ENTIRE PROJECT CAN VARY SIGNIFICANTLY FROM CONTRACTOR TO CONTRACTOR. THE CONTRACTOR IS RESPONSIBLE FOR PROVIDING A DETAILED SEQUENCE OF CONSTRUCTION FOR ALL CONSTRUCTION ACTIVIES IN SECTION 104 EROSION CONTROL

FOR EACH CONSTRUCTION PHASE, INSTALL PERIMETER CONTROLS BEFORE BEGINNING OTHER WORK FOR THE CONSTRUCTION PHASE. REMOVE PERIMETER CONTROLS ONLY AFTER DISTURBED AREAS ARE

C. AREA ESTIMATES

TOTAL SITE AREA: 5.49 AC. TOTAL AREA DISTURBED:

D. RUNOFF DATA:

RUNOFF COEFFICIENT:

BEFORE: 0.30 (UNPAVED); 0.98 (PAVED) DURING: FROM 0.30 TO 0.50 (UNPAVED); 0.30 TO 0.98 (PAVED)

AFTER: 0.30 (UNPAVED); 0.98 (PAVED)

SEE ATTACHED GEOTECHNICAL REPORT

OUTFALL INFORMATION:

ALL DRAINAGE WILL CONNECT TO EXISTING OUTFALLS.

E. SITE MAP:

THE LOCATION MAP ON THE KEY SHEET DESCRIBES THE SITE.

DRAINAGE PATTERNS: EXISTING DRAINAGE FLOWS GENERALLY TO LOCAL DRAINAGE NETWORKS OR DIRECTLY TO ADJACENT WOODS AND ULTIMATELY TO NORTH BAY.

APPROXIMATE SLOPES: 0 TO 5 PERCENT AREA OF SOIL DISTURBANCE: PROPOSED SITE, DRIVEWAYS, PARKING, AND DEMOLISHED FACILITIES. AREAS NOT TO BE DISTURBED: OUTSIDE OF EXISTING PROJECT LIMITS.

LOCATIONS OF TEMPORARY CONTROLS: TEMPORARY STABILIZATION PRACTICES WILL BE DESCRIBED IN THE NARRATIVE.

LOCATIONS OF PERMANENT CONTROLS: LOCATION OF PERMANENT STABILIZATION IS SHOWN ON THE PLANS. AREAS TO BE STABILIZED:

TEMPORARY STABILIZATION PRACTICES ARE SHOWN IN THE SAME LOCATION AS THE TEMPORARY CONTROLS MENTIONED ABOVE. PERMANENT STABILIZATION IS SHOWN ON THE PLAN

SURFACE WATERS: NONE

DISCHARGE POINTS TO SURFACE WATERS: NO NEW DISCHARGE POINTS.

#### F. RECEIVING WATERS:

RUNOFF FROM THE EXISTING DRAINAGE SYSTEM DISCHARGES THROUGH TREATMENT FACILITIES TO NORTH BAY.

#### 2.0 CONTROLS

A. EROSION AND SEDIMENT CONTROLS:

THE FOLLOWING DISCUSSION DEFINES GENERAL GUIDELINES FOR THE SEQUENCES OF CONSTRUCTION AND THE USE OF STABILIZATION AND STRUCTURAL PRACTICES. THE CONTRACTOR IS ALSO RESPONSIBLE FOR DOCUMENTING THIS PORTION OF THE SWPPP IN THE SECTION 104 EROSION CONTROL PLAN. ALL ITEMS REPRESENTED IN THE FOLLOWING DISCUSSION ARE TREATED IN DETAIL IN THE "FLORIDA DEPARTMENT OF TRANSPORTATION STANDARD SPECIFICATIONS FOR ROAD AND BRIDGE CONSTRUCTION" (2010). THE CONTRACTOR SHALL GENERATE AN IMPLEMENTATION SCHEDULE FOR EACH PHASE OF CONSTRUCTION OPERATIONS OR ACTIVITIES.

1. STABILIZATION PRACTICES:

IN THE SECTION 104 EROSION CONTROL PLAN, THE CONTRACTOR SHALL DESCRIBE THE STABILIZATION PRACTICES PROPOSED TO CONTROL EROSION. THE CONTRACTOR SHALL INITIATE ALL STABILIZATION MEASURES AS SOON AS PRACTICAL BUT IN NO CASE IN MORE THAN 7 DAYS. THE STABILIZATION PRACTICES SHALL INCLUDE AT LEAST THE FOLLOWING, UNLESS OTHERWISE APPROVED BY THE ENGINEER.

SOD IN ACCORDANCE WITH SPECIFICATION SECTION 575. ALL STABILIZATION PRACTICES SHALL BE INITIATED AS SOON AS PRACTICABLE IN PORTIONS OF THE SITE WHERE CONSTRUCTION ACTIVITIES ARE TEMPORARILY OR PERMANENTLY CEASED. THE CONTRACTOR IS ALSO RESPONSIBLE FOR DOCUMENTING THIS PORTION OF THE SWPPP ON THE SECTION 104 EROSION CONTROL PLAN.

SEED AND MULCH AND SOD IN ACCORDANCE WITH SPECIFICATION SECTION 104.

2. STRUCTURAL PRACTICES:

ALL SEDIMENT CONTROLS SHALL BE IN PLACE PRIOR TO ANY SOIL DISTURBING ACTIVITY UPSTREAM OF THE CONTROL. THE CONTRACTOR IS ALSO RESPONSIBLE FOR DOCUMENTING THIS PORTION OF THE SWPPP ON THE SECTION 104 EROSION CONTROL PLAN.

SEDIMENT BARRIERS, TURBIDITY BARRIERS AND INLET PROTECTION

B. STORMWATER MANAGEMENT

STORMWATER WILL BE CONVEYED THROUGH CLOSED CONVEYANCE SYSTEMS AND DITCHES TO LOCAL STORMWATER TREATMENT FACILITIES.

C. OTHER CONTROLS

1. WASTE DISPOSAL

IN THE SECTION 104 EROSION CONTROL PLAN, THE CONTRACTOR SHALL DESCRIBE PROPOSED METHODS TO PREVENT THE DISCHARGE OF SOLID MATERIALS, INCLUDING BUILDING MATERIALS, TO WATERS OF THE UNITED STATES. THE PROPOSED METHODS SHALL INCLUDE AT LEAST THE FOLLOWING, UNLESS OTHERWISE APPROVED BY THE

PROVIDE LITTER CONTROL AND COLLECTION WITHIN THE PROJECT DURING CONSTRUCTION ACTIVITES.

DISPOSE OF ALL FERTILIZER OR OTHER CHEMICAL CONTAINERS ACCORDING TO EPA'S STANDARD PRACTICES AS DETAILED BY THE MANUFACTURER.

DISPOSE OF SOLID MATERIALS INCLUDING BUILDING AND CONSTRUCTION MATERIALS OFFSITE BUT NOT IN SURFACE WATERS OR WETLANDS.

#### 2. OFFSITE VEHICLE TRACKING:

IN THE SECTION 104 EROSION CONTROL PLAN, THE CONTRACTOR SHALL DESCRIBE THE PROPOSED METHODS FOR MINIMIZING OFFSITE VEHICLE TRACKING OF SEDIMENTS AND GENERATING DUST. UNLESS APPROVED BY THE ENGINEER, THE PROPOSED METHODS SHALL INCLUDE AT LEAST THE FOLLOWING.

COVERING LOADED HAUL TRUCKS WITH TARPAULINS.

#### REMOVING EXCESS DIRT FROM ROADS DAILY.

STABILIZING CONSTRUCTION ENTRANCES ACCORDING TO DESIGN STANDARD 106.

USING ROADWAY SWEEPERS DURING DUST GENERATING ACTIVITIES SUCH AS EXCAVATION AND MILLING OPERATIONS.

#### 3. STATE AND LOCAL REGULATIONS FOR WASTE DISPOSAL, SANITARY SEWER

OR SEPTIC TANK IN THE SECTION 104 EROSION CONTROL PLAN, THE CONTRACTOR SHALL DESCRIBE THE PROPOSED PROCEDURES TO COMPLY WITH APPLICABLE STATE AND LOCAL REGULATIONS FOR WASTE DISPOSAL, SANITARY SEWER AND SEPTIC SYSTEMS.

#### 4. FERTILIZERS AND PESTICIDES:

FERTILIZERS SHALL BE APPLIED ACCORDING TO SPECIFICATION SECTION 570 OR 577 OF THE FDOT STANDARD SPECIFICATIONS. THE CONTRACTOR IS ALSO RESPONSIBLE FOR DOCUMENTING THIS PORTION OF THE SWPPP ON THE SECTION 104 EROSION CONTROL PLAN.

#### 5. TOXIC SUBSTANCES:

IN THE SECTION 104 EROSION CONTROL PLAN, THE CONTRACTOR SHALL PROVIDE A LIST OF TOXIC SUBSTANCES THAT ARE LIKELY TO BE USED ON THE JOB AND PROVIDE A PLAN ADDRESSING THE GENERATION, APPLICATION, MIGRATION, STORAGE AND DISPOSAL OF THESE SUBSTANCES.

#### 3.0 MAINTENANCE

PROPOSED REPLACEMENT MAINTENANCE ITEM SILT FENCE

IN ACCORDANCE WITH SECTION 104 1 YEAR

INTERVAL

REMOVE MILLED MATERIAL AND DEBRIS 1 YEAR **INLET PROTECTION** FROM BAGS TO KEEP FROM ENTERING TRAFFIC LANE AND CURB INLETS

THE CONTRACTOR IS ALSO RESPONSIBLE FOR DOCUMENTING THIS PORTION OF THE SWPPP ON THE SECTION 104 EROSION CONTROL PLAN

#### 4.0 INSPECTIONS

QUALIFIED PERSONNEL SHALL INSPECT THE FOLLOWING ITEMS AT LEAST ONCE EVERY SEVEN CALENDAR DAYS AND WITHIN 24 HOURS OF THE END OF A STORM THAT IS 0.5 INCHES OR GREATER. THE ENGINEER SHALL BE RESPONSIBLE FOR COMPLETING THE WEEKLY INSPECTION REPORT FORM AND SUBMISSION OF THE FORM TO THE FDOT CENTRAL OFFICE ON A MONTHLY BASIS. WHERE SITES HAVE BEEN FINALLY STABILIZED, INSPECTIONS SHALL BE CONDUCTED AT LEAST ONCE EVERY MONTH.

#### - POINTS OF DISCHARGE TO WATERS OF THE UNITED STATES

- DISTURBED AREAS OF THE SITE THAT HAVE NOT BEEN FINALLY STABILIZED

- STRUCTURAL CONTROLS

- AREAS USED FOR STORAGE OF MATERIALS THAT ARE EXPOSED TO PRECIPITATION

- LOCATIONS WHERE VEHICLES ENTER OR EXIT THE SITE

#### 5.0 NON-STORMWATER DISCHARGES

THE CONTRACTOR IS ALSO RESPONSIBLE FOR DOCUMENTING THIS PORTION OF THE SWPPP ON THE SECTION 104 EROSION CONTROL PLAN. IF CONTAMINATED SOIL OR GROUNDWATER IS ENCOUNTERED, CONTACT THE PROJECT ADMINISTRATOR AND ENGINEER OF RECORD

#### PHASING OF IMPLEMENTATION

#### PHASE I - INSTALLATION OF ENVIRONMENTAL CONTROL FEATURES

ENVIRONMENTAL CONTROL FEATURES AS PROVIDED IN PLANS QUANTITIES ARE TO BE INSTALLED THROUGHOUT THE CONSTRUCTION LIMITS, AT ENVIRONMENTALLY SENSITIVE AREAS AS SHOWN ON THE PLANS, OR AT AREAS AS DIRECTED BY THE PROJECT ADMINISTRATOR. THESE FEATURES INCLUDE, BUT ARE NOT LIMITED TO, SILT FENCE, SYNTHETIC BALES, ETC.

#### PHASE II - SITE WORK OPERATIONS

SITE WORK SHALL BE DONE AS INDICATED ON THE PLANS.

#### PHASE III - DRAINAGE SYSTEM OR STRUCTURE ENVIRONMENTAL CONTROL FEATURES

ENVIRONMENTAL CONTROL FEATURES AS PROVIDED IN PLANS ARE TO BE INSTALLED AT ALL AREAS OF EXCAVATION OR FILL FOR DRAINAGE SYSTEM OR STRUCTURE CONSTRUCTION PRIOR TO SUCH EXCAVATION OR FILL. ALL STREAMS OR DITCHES ARE TO BE PROTECTED FROM EROSION OR SILTATION BY METHODS DETAILED IN THE STANDARD INDICES. THESE INCLUDE SILT FENCE, SYNTHETIC BALES, ETC.

#### PHASE IV - MAINTENANCE OF ENVIRONMENTAL CONTROL FEATURES

ALL ENVIRONMENTAL CONTROL FEATURES ARE TO BE MAINTAINED THROUGHOUT THE LIFE OF THE PROJECT AS NECESSARY FOR THE VARIOUS CONSTRUCTION PHASES. THE CONTRACTOR MUST INSURE THAT ALL OF THESE FEATURES FUNCTION PROPERLY AT ALL TIMES.

#### **GENERAL NOTES**

- 1. THE CONTRACTOR MAY CONSTRUCT THE PROJECT IN SEGMENTS BUT EACH OF THE ABOVE PHASES MUST BE FOLLOWED FOR EACH SEGMENT.
- 2. ALL EROSION AND MATERIAL DEPOSITS MUST BE CONTAINED WITHIN THE PROJECT

#### STORMWATER SYSTEM MAINTENANCE NOTES:

- 1. CONTRACTOR SHALL STAGE AND TIME CONSTRUCTION TO MINIMIZE THE SIZE OF EXPOSED SOIL AREAS AND THE TIME BETWEEN EXPOSING THE SOIL AREA AND FINISHING THE SOIL AREA.
- 2. IT SHALL BE THE RESPONSIBILITY OF THE CONTRACTOR PERFORMING A TASK TO PROVIDE EROSION CONTROL UNLESS ANOTHER PARTY HAS BEEN PREVIOUSLY SPECIFIED AS RESPONSIBLE FOR THE EROSION CONTROL ASSOCIATED WITH THAT TASK. IN THE EVENT ANOTHER PARTY IS RESPONSIBLE FOR EROSION CONTROL, THE CONTRACTOR SHALL STILL BE RESPONSIBLE FOR COORDINATION WITH THE PARTY RESPONSIBLE. IN THE EVENT THAT DAMAGE TO THE CONSTRUCTED ITEM RESULTS ARE DUE TO LACK OF EROSION CONTROL, THE CONTRACTOR SHALL REPAIR OR REPLACE THE ITEM AT NO CHARGE TO THE OWNER.
- 3. THE CONTRACTOR IS TO PROVIDE EROSION CONTROL/ SEDIMENTATION BARRIER (HAY BALES, SILT FENCE, TURBIDITY BARRIER, OR AS SPECIFIED IN THE CONSTRUCTION DRAWINGS) TO PREVENT SILTATION OF ADJACENT PROPERTY, STREETS, STORM SEWERS, WATERWAYS, AND WETLAND OR JURISDICTIONAL AREAS. IF, IN THE OPINION OF THE ENGINEER, AND/OR REGULATORY AUTHORITIES, EXCESSIVE QUANTITIES OF MATERIAL ARE TRANSPORTED OFF-SITE BY EROSION OR STORMWATER RUNOFF, THE CONTRACTOR SHALL IMPROVE CONDITIONS TO THE SATISFACTION OF THE ENGINEER AND/OR AUTHORITIES AT NO ADDITIONAL COST TO THE OWNER. IN NO CASE SHALL CONSTRUCTION COMMENCE PRIOR TO INSTALLATION OF EROSION CONTROL/SEDIMENTATION BARRIER.
- 4. CONTRACTOR SHALL PLACE STRAW, MULCH, OR OTHER SUITABLE MATERIAL ON GROUND IN AREAS WHERE CONSTRUCTION-RELATED TRAFFIC IS TO ENTER AND EXIT SITE.
- 5. IF WIND EROSION BECOMES SIGNIFICANT DURING CONSTRUCTION, THE CONTRACTOR SHALL STABILIZE THE AREA USING SPRINKLING IRRIGATION OR OTHER ACCEPTABLE METHODS.
- 6. ALL NEW DRAINAGE PIPE SHALL BE AS INDICATED ON PLANS OR APPROVED EQUAL.
- 7. CONTRACTOR SHALL BE RESPONSIBLE FOR CONSTRUCTION MONITORING, NOTICE OF COMMENCEMENT, AND AS-BUILT CERTIFICATION.
- 8. CONTRACTOR SHALL PREPARE A DEWATERING AND STOCKPILE PLAN AS PART OF THE NPDES PERMIT PROCESS.

9. THE OWNER IS TO MAINTAIN THE STORMWATER SYSTEM PER THE OPERATION AND MAINTENANCE PLAN.

648 Florida Avenue Panama City, Fl. 32401 P 850/257-5400

JONATHAN SKLARSKI FL. P.E. 67361

Principal in Charge Joseph J. Sorci

Project Number: 4166-15 Date Issued: 5-4-2017 Drawn By: Checked By: J.S.

BID No. ITB#8-2016/2017


Revisions:



G COLL ME


STATE 0 PR AST 00 GULF

CONSTRUCTION DOCUMENTS

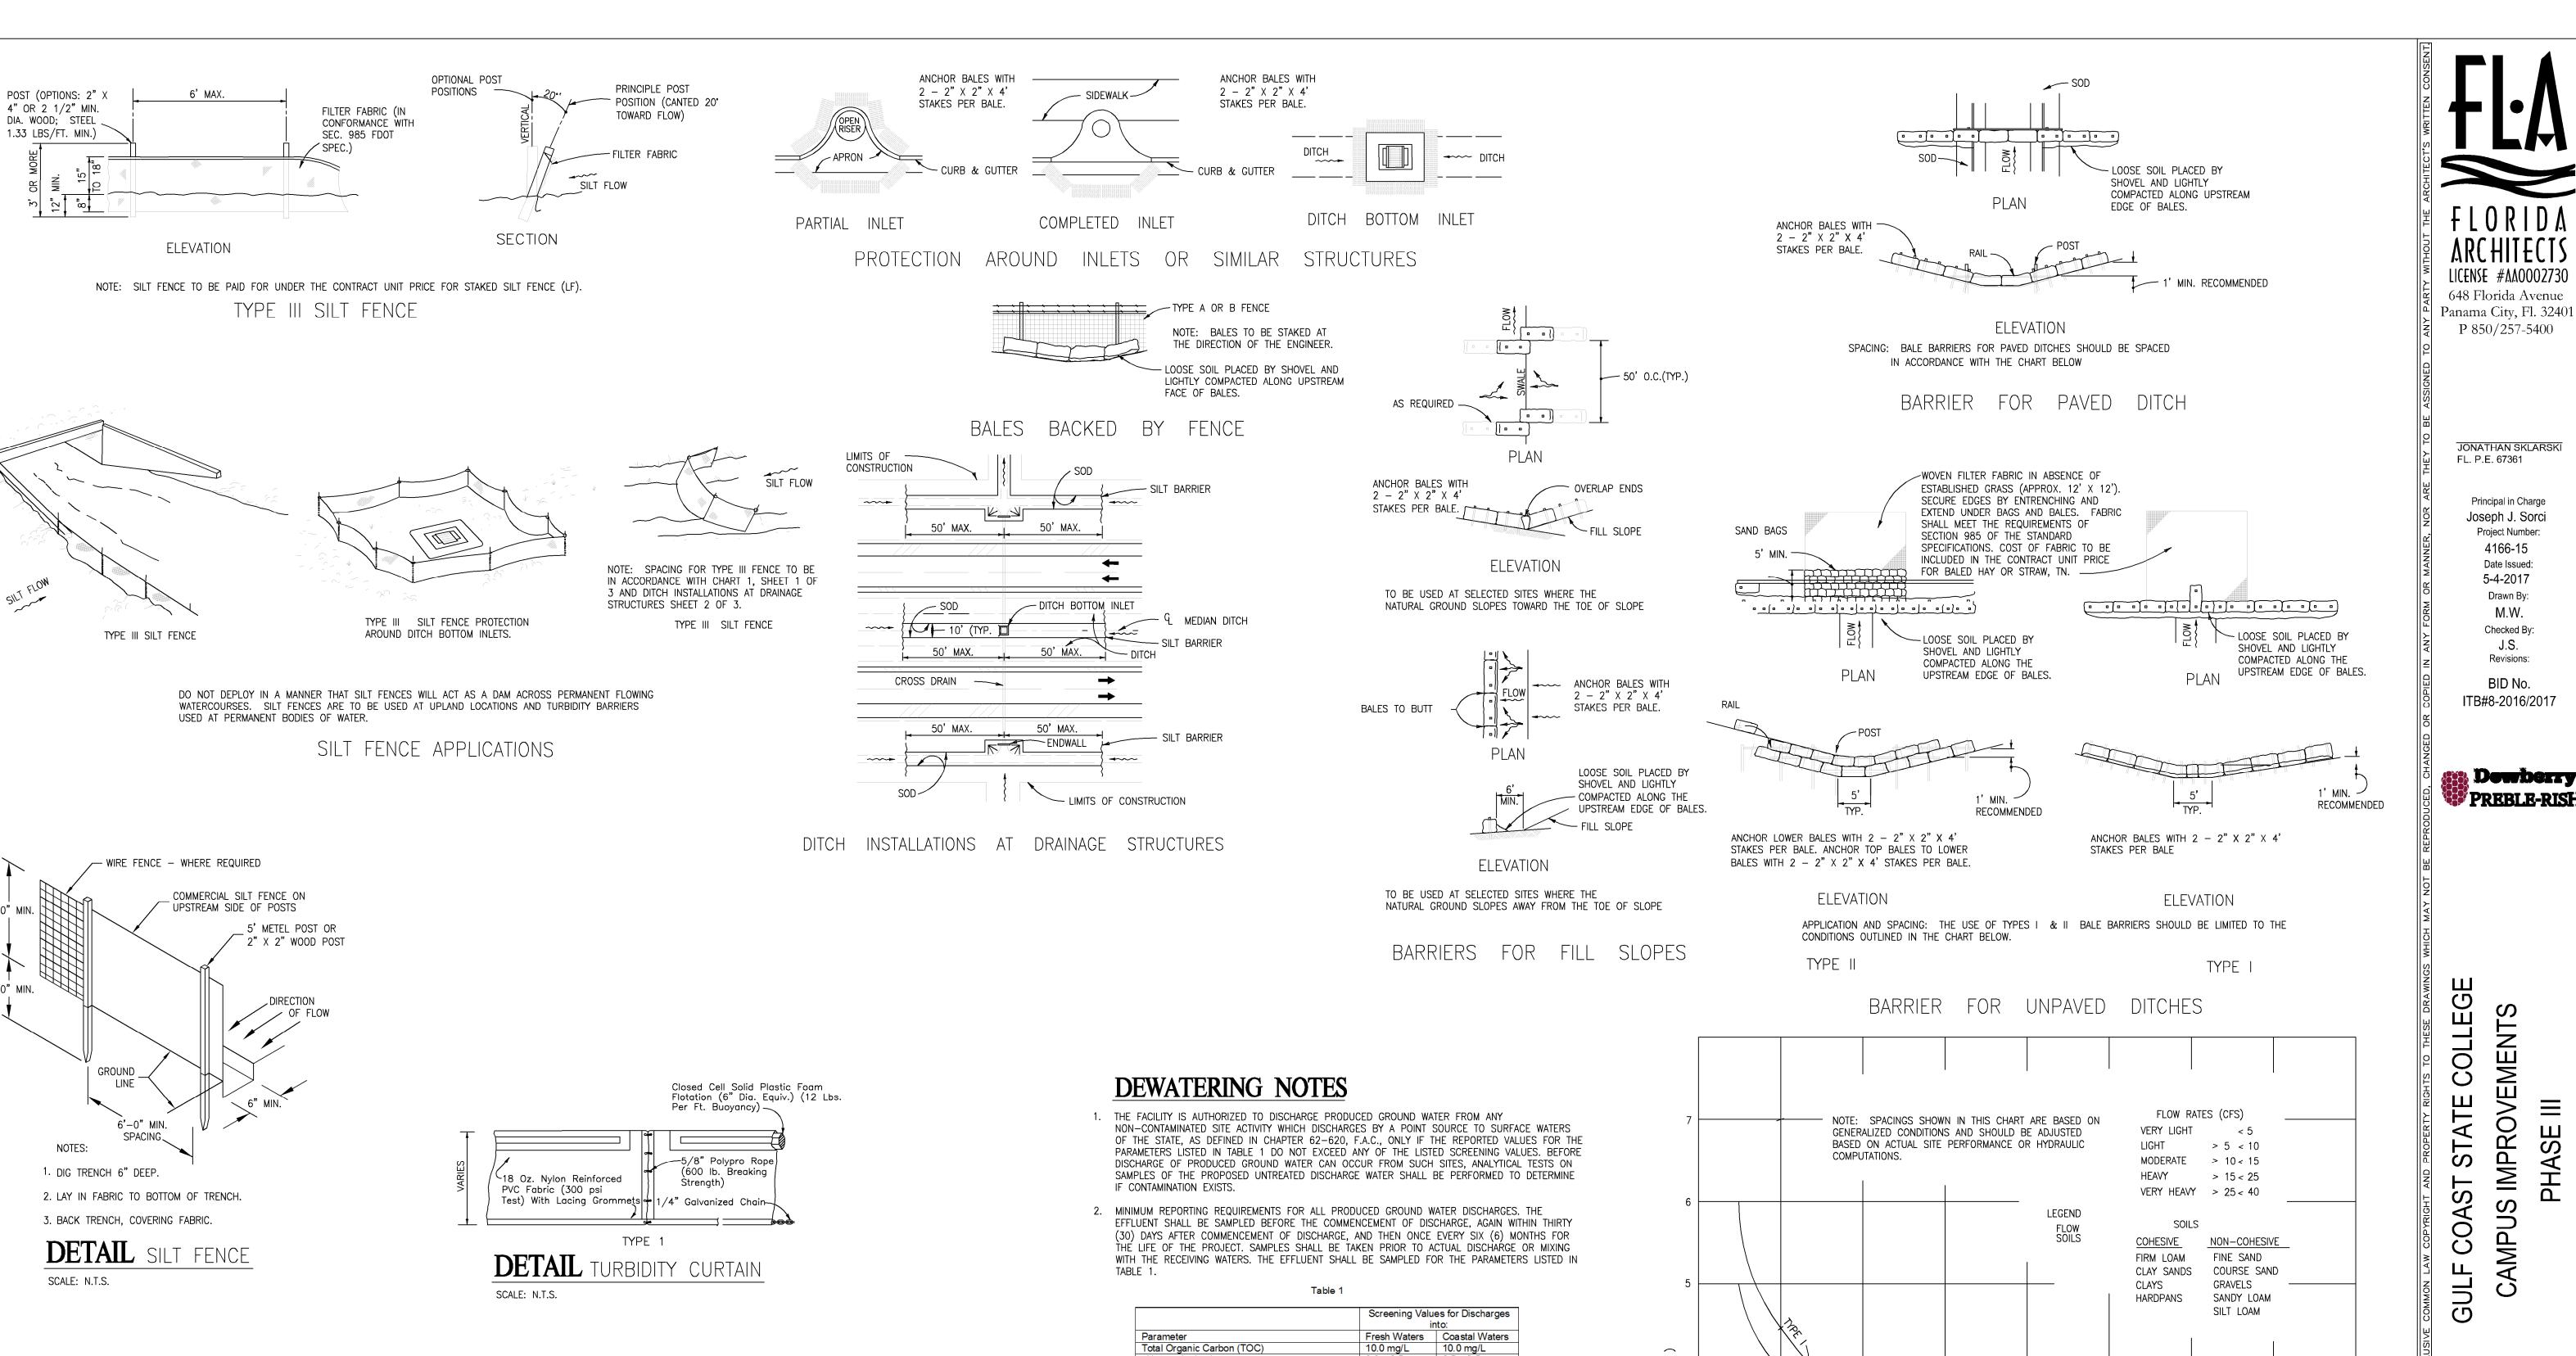

	Screening Values for Discharges						
	into:						
Parameter	Fresh Waters	Coastal Waters					
Total Organic Carbon (TOC)	10.0 mg/L	10.0 mg/L					
pH, standard units	6.0 - 8.5	6.5 - 8.5					
Total Recoverable Mercury	0.012 µg/L	0.025 µg/L					
Total Recoverable Cadmium	9.3 µg/L	9.3 µg/L					
Total Recoverable Copper	2.9 µg/L	2.9 µg/L					
Total Recoverable Lead	0.03 mg/L	5.6 µg/L					
Total Recoverable Zinc	86.0 µg/L	86.0 µ/L					
Total Recoverable Chromium (Hex.)	11.0 µg/L	50.0 μg/L					
Benzene	1.0 µg/L	1.0 µg/L					
Naphthalene	100.0 μg/L	100.0 µg/L					

- 3. FOR FRESH WATERS AND COASTAL WATERS, THE PH OF THE EFFLUENT SHALL NOT BE LOWERED TO LESS THAN 6.0 UNITS FOR FRESH WATERS, OF LESS THAN 6.5 UNITS FOR COASTAL WATERS, OR RAISED ABOVE 8.5 UNITS, UNLESS NATURAL BACKGROUND DATA CONFIRMING A NATURAL BACKGROUND PH OUTSIDE OF THIS RANGE IS SUBMITTED. IF NATURAL BACKGROUND OF THE RECEIVING WATER IS DETERMINED TO BE LESS THAN 6.0 UNITS FOR FRESH WATERS, OR LESS THAN 6.5 UNITS IN COASTAL WATERS, THE PH SHALL NOT VARY BELOW NATURAL BACKGROUND OR VARY MORE THAN ONE (1) UNIT ABOVE NATURAL BACKGROUND FOR FRESH AND COASTAL WATERS. IF NATURAL BACKGROUND OF THE RECEIVING WATER IS DETERMINED TO BE HIGHER THAN 8.5 UNITS, THE PH SHALL NOT VARY ABOVE NATURAL BACKGROUND OR VARY MORE THAN ONE (1) UNIT BELOW NATURAL BACKGROUND OF FRESH AND COASTAL WATERS. THE CONTRACTOR SHALL INCLUDE THE NATURAL BACKGROUND PH OF THE RECEIVING WATERS WITH THE RESULTS OF THE ANALYSES LISTED IN NOTE 2. FOR PURPOSES OF THIS SECTION ONLY, FRESH WATERS ARE THOSE HAVING A CHLORIDE CONCENTRATION OF LESS THAN 1500 MG/L, AND COASTAL WATERS ARE THOSE HAVING A CHLORIDE CONCENTRATION EQUAL TO OR GREATER THAN 1500 MG/L.
- 4. IN ACCORDANCE WITH RULE 62-302.500 (1) (A-C), F.A.C., THE DISCHARGE SHALL AT ALL TIMES BE FREE FROM FLOATING SOLIDS, VISIBLE FOAM, TURBIDITY, OR VISIBLE OIL IN SUCH AMOUNTS AS TO FORM NUISANCES ON SURFACE WATERS.
- 5. ALL OF THE GENERAL CONDITIONS LISTED IN RULE 62-621.250, F.A.C., ARE APPLICABLE.

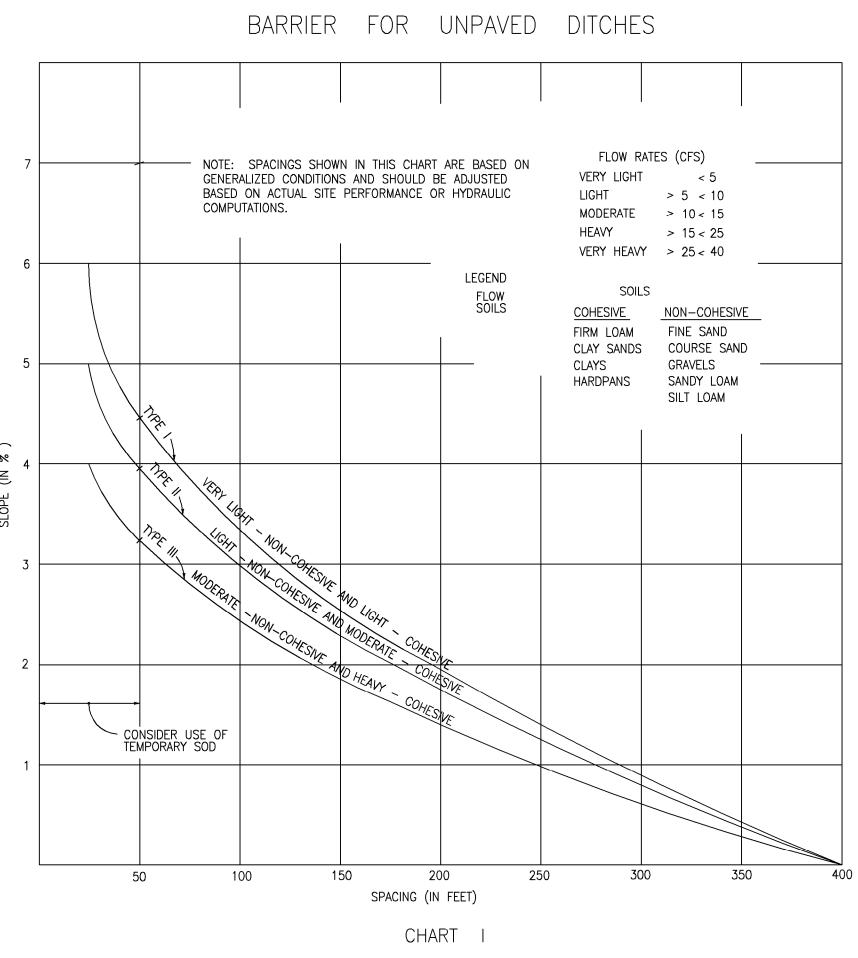

RECOMMENDED SPACING FOR TYPE I AND TYPE II HAY BALE BARRIERS, AND TYPE III SILT FENCES

CONSTRUCTION DOCUMENTS

LICENSE #AA0002730

P 850/257-5400

JONATHAN SKLARSKI

Principal in Charge

Joseph J. Sorci

Project Number:

4166-15

5-4-2017

Drawn By:

M.W.

Checked By:

J.S.

Revisions:

BID No.

ITB#8-2016/2017

Dewberry

PREBLE-RISH

COLLEGE

STATE

COAST

GULF

AIL

SWPPP


MENT


IMPROVE

CAMPUS


Date Issued:


FL. P.E. 67361

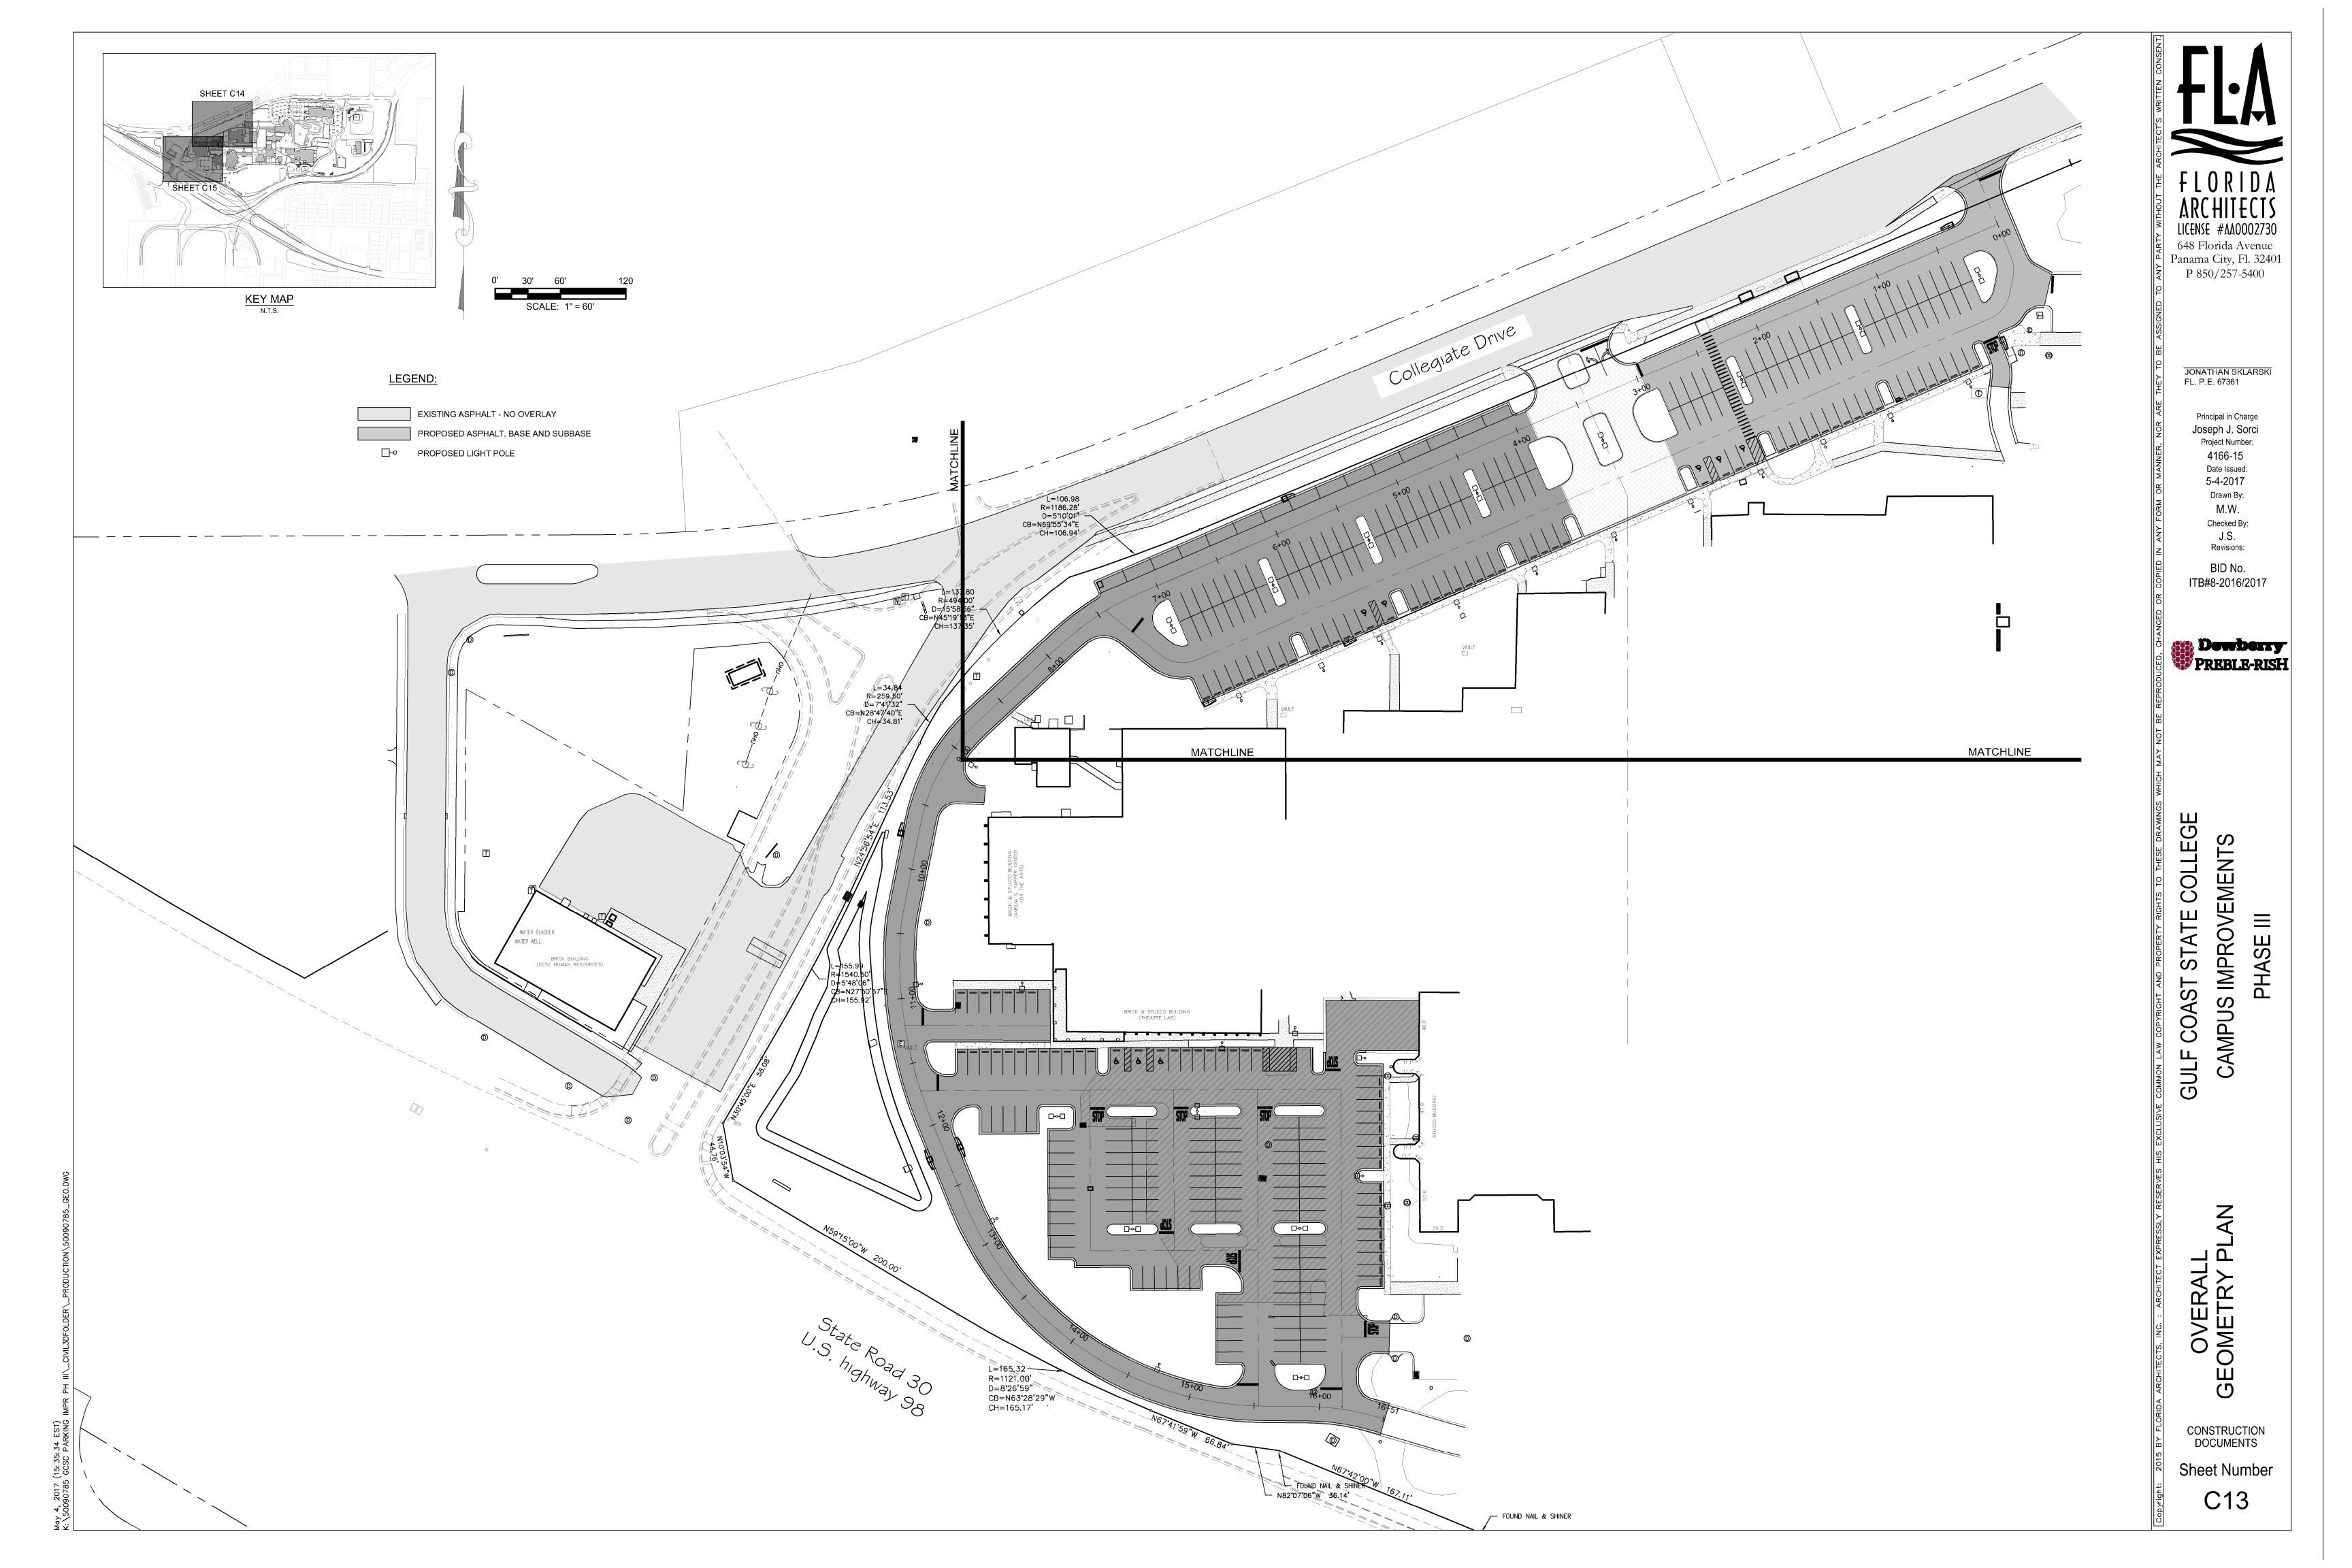


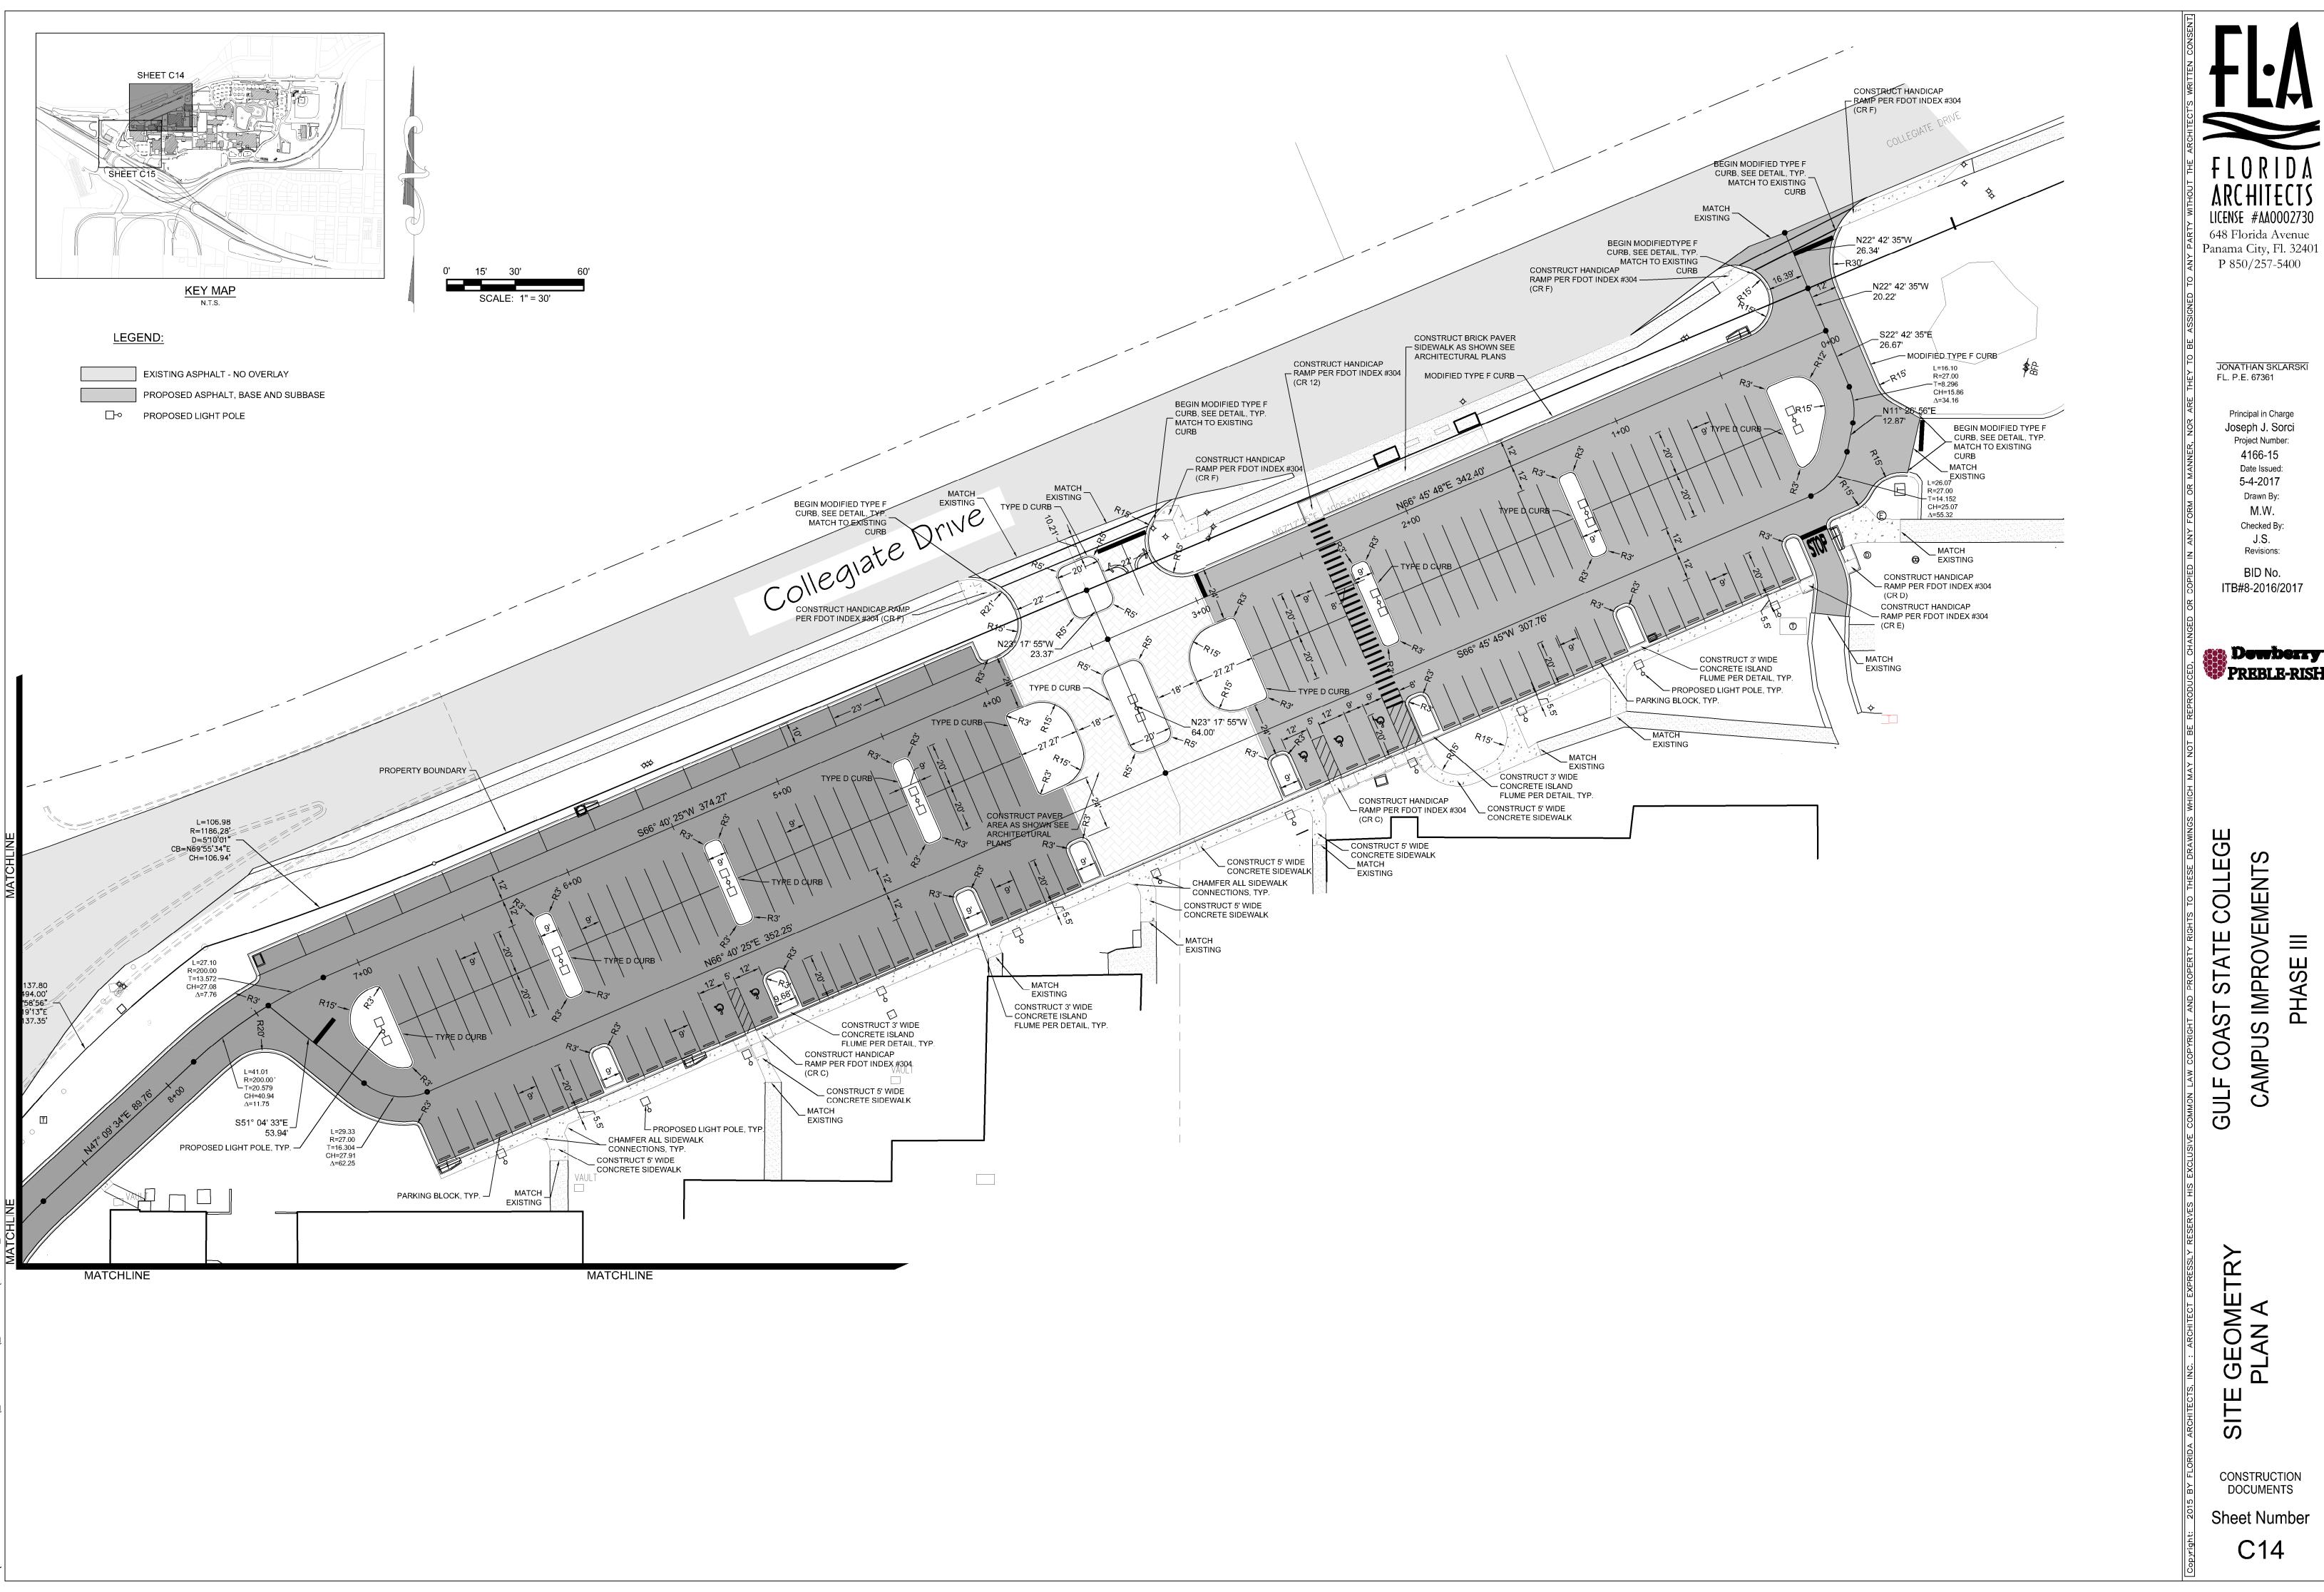




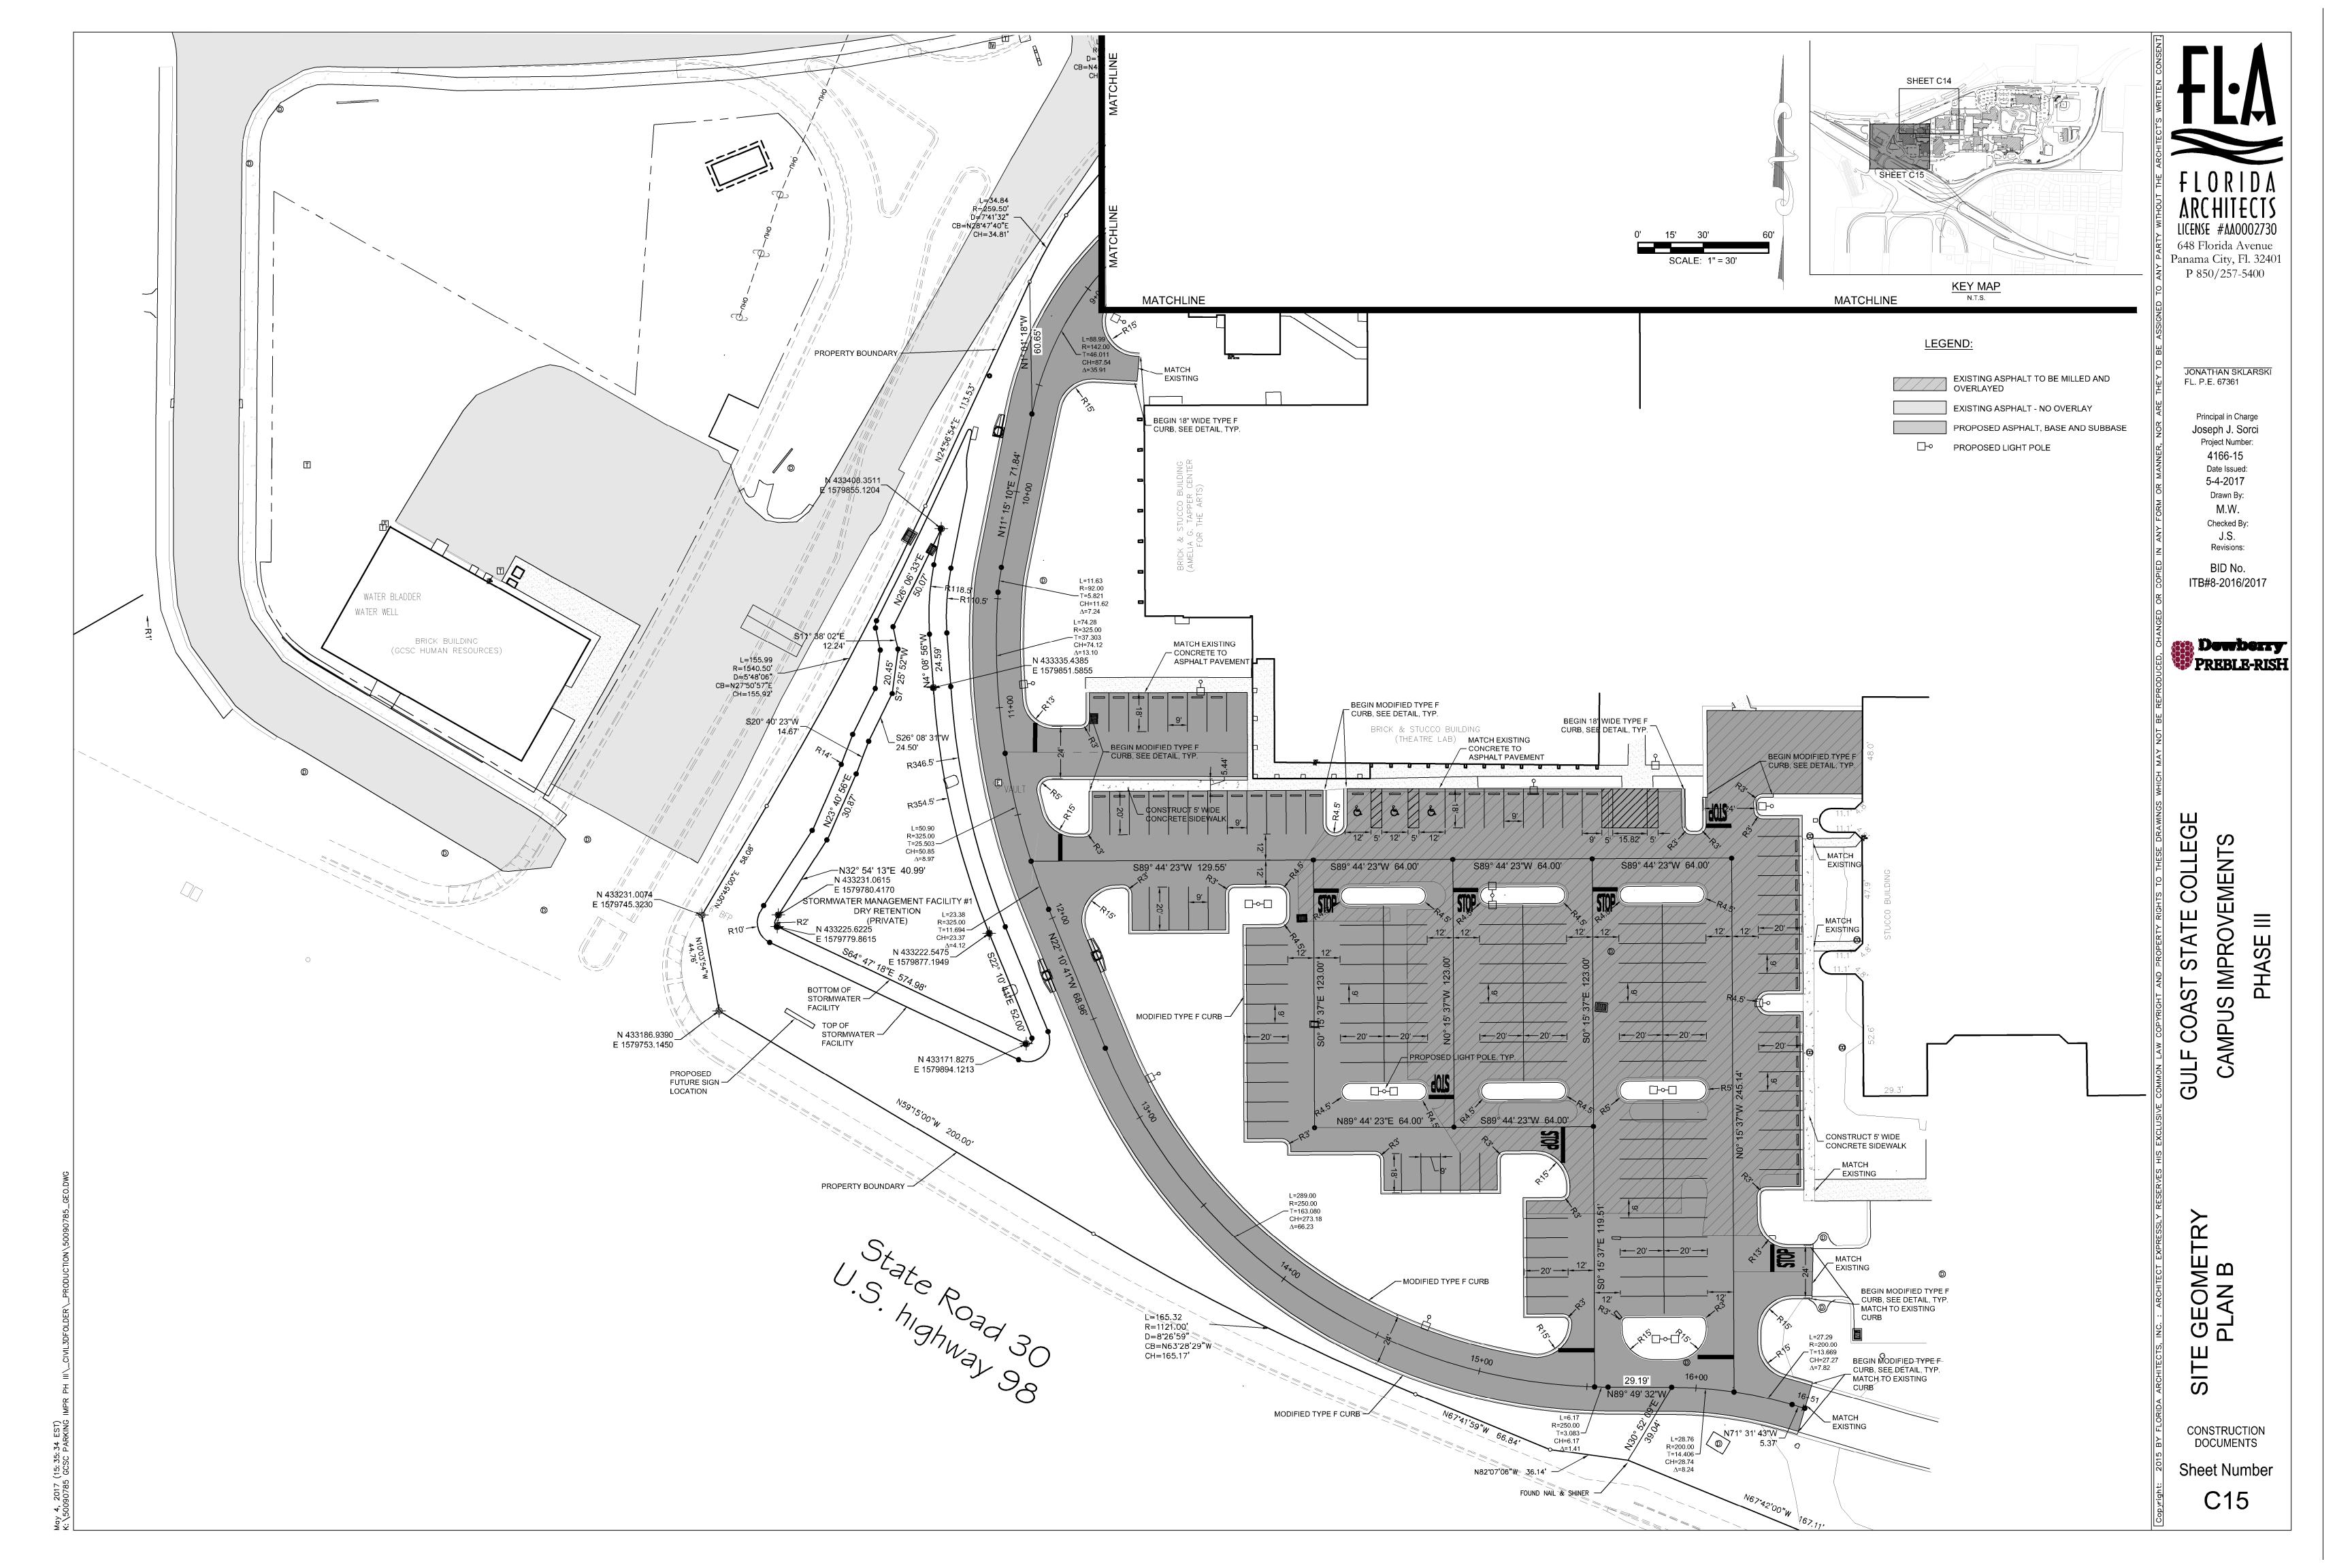

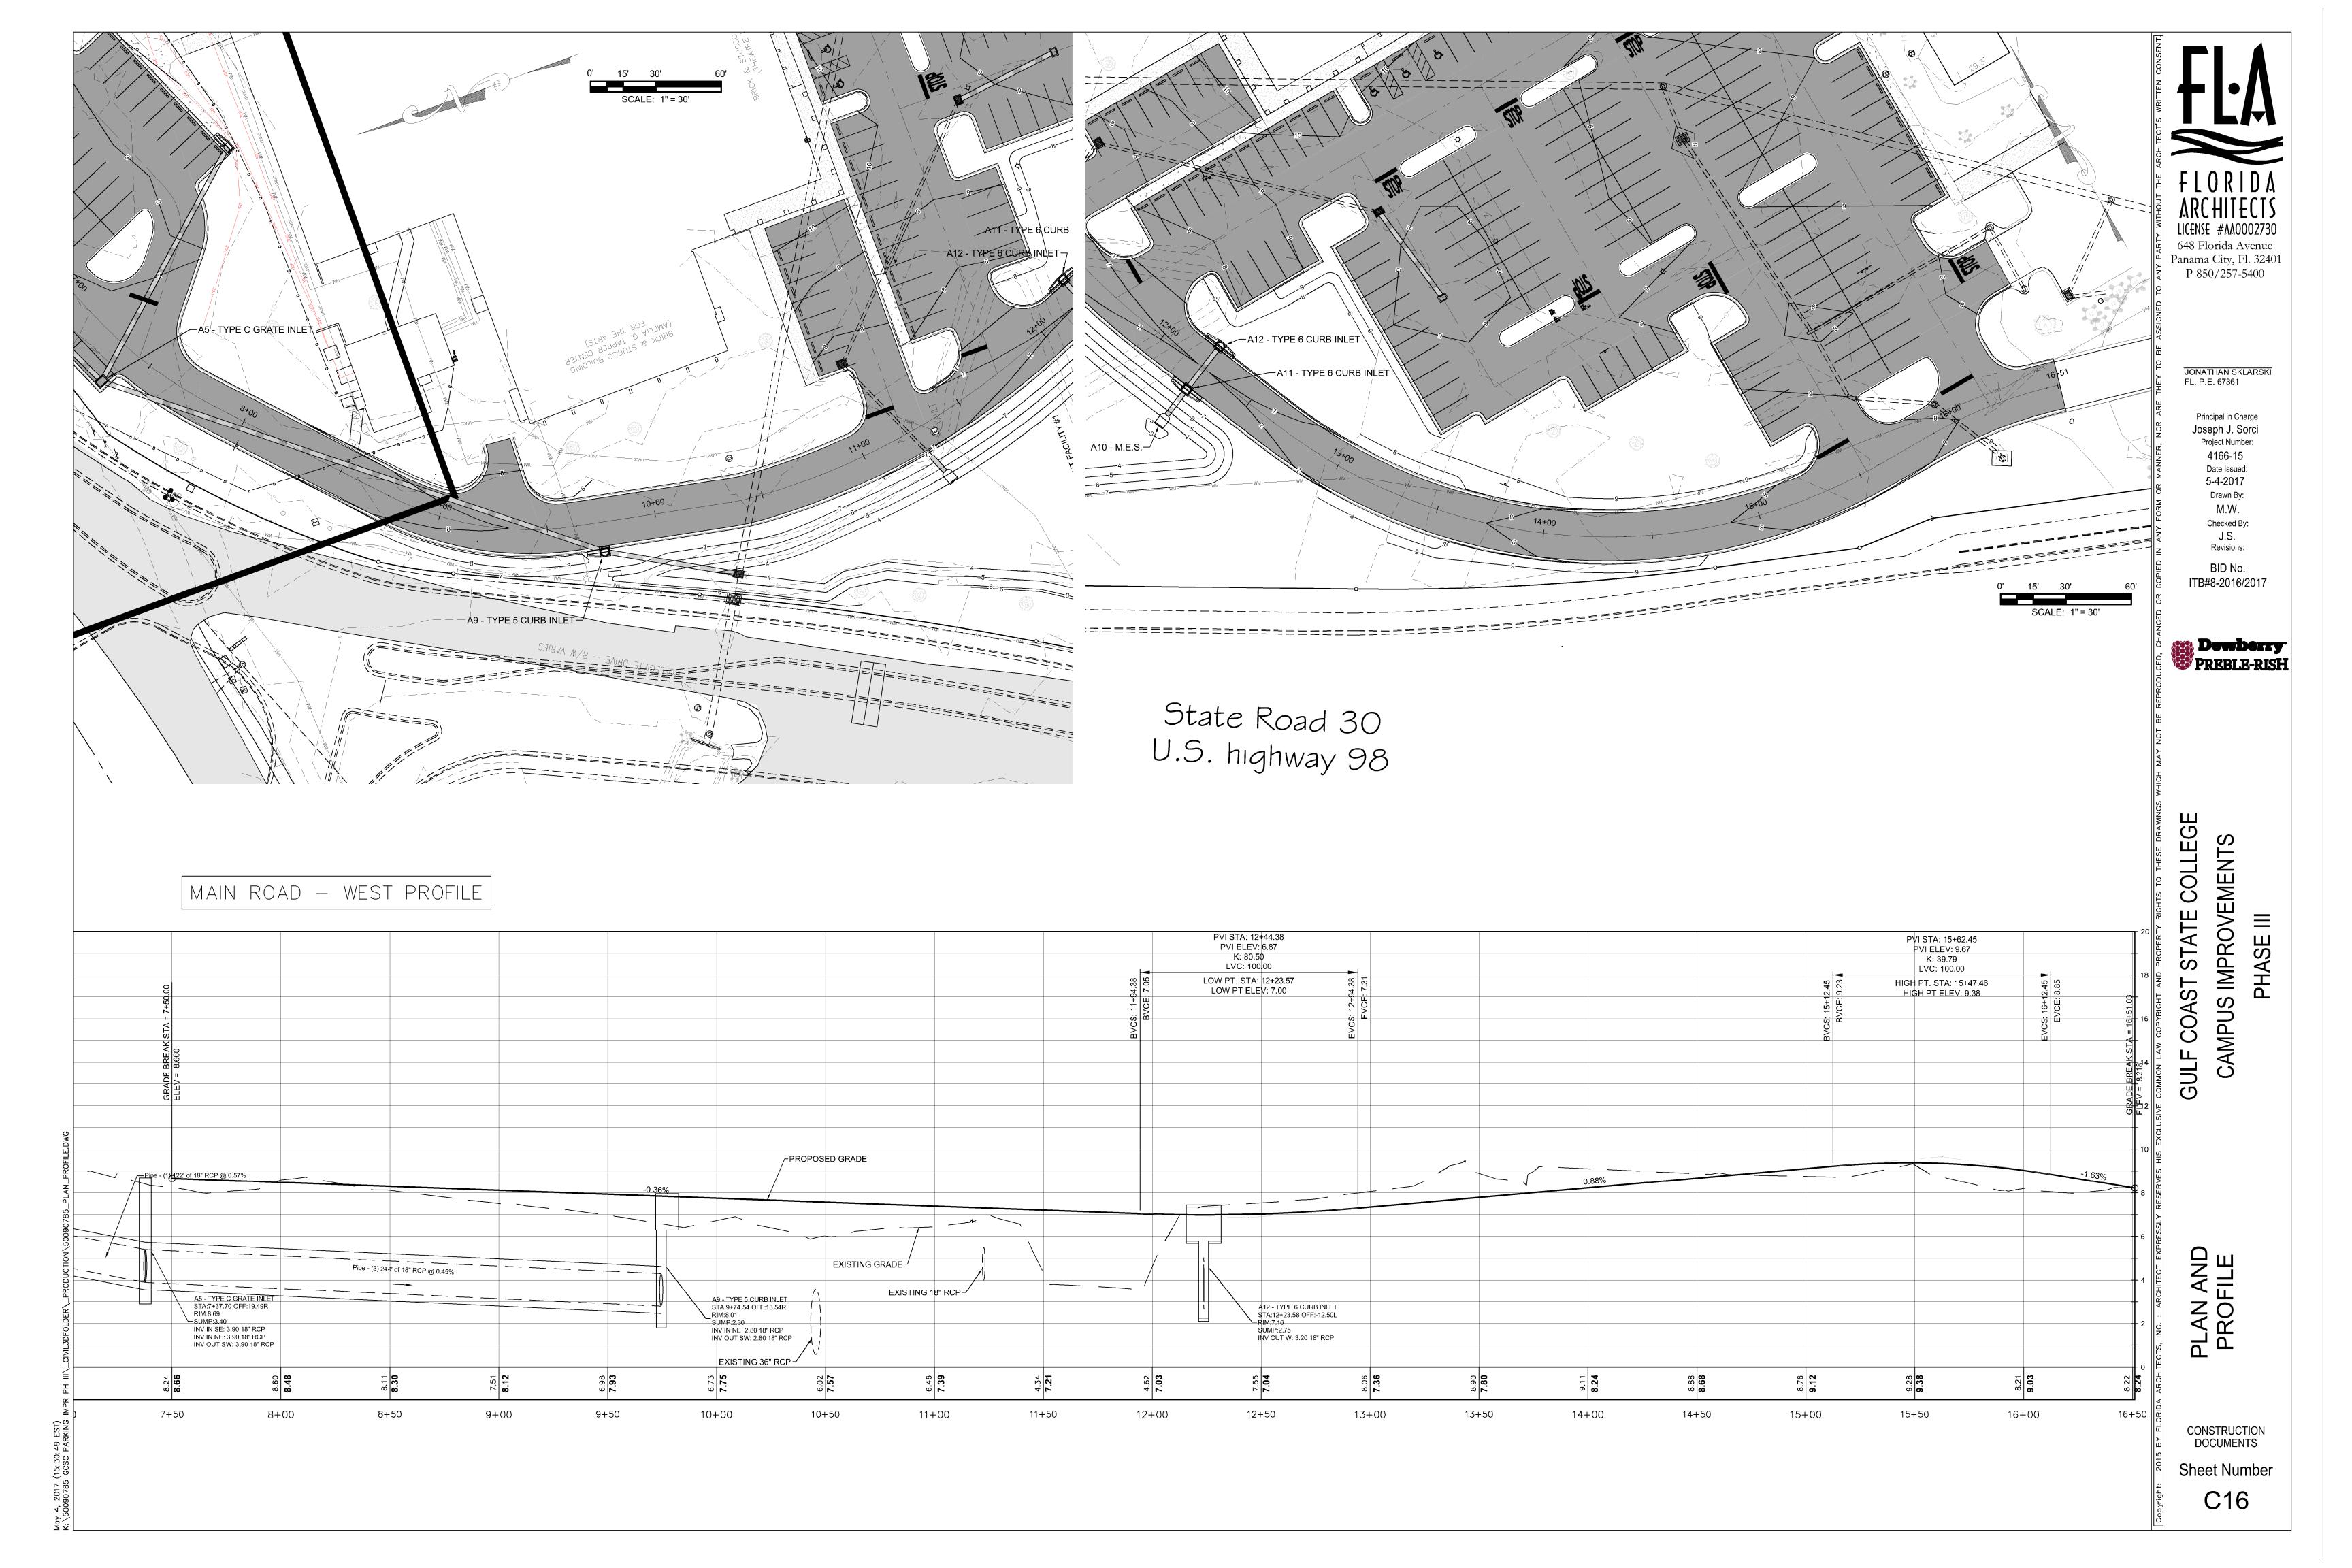

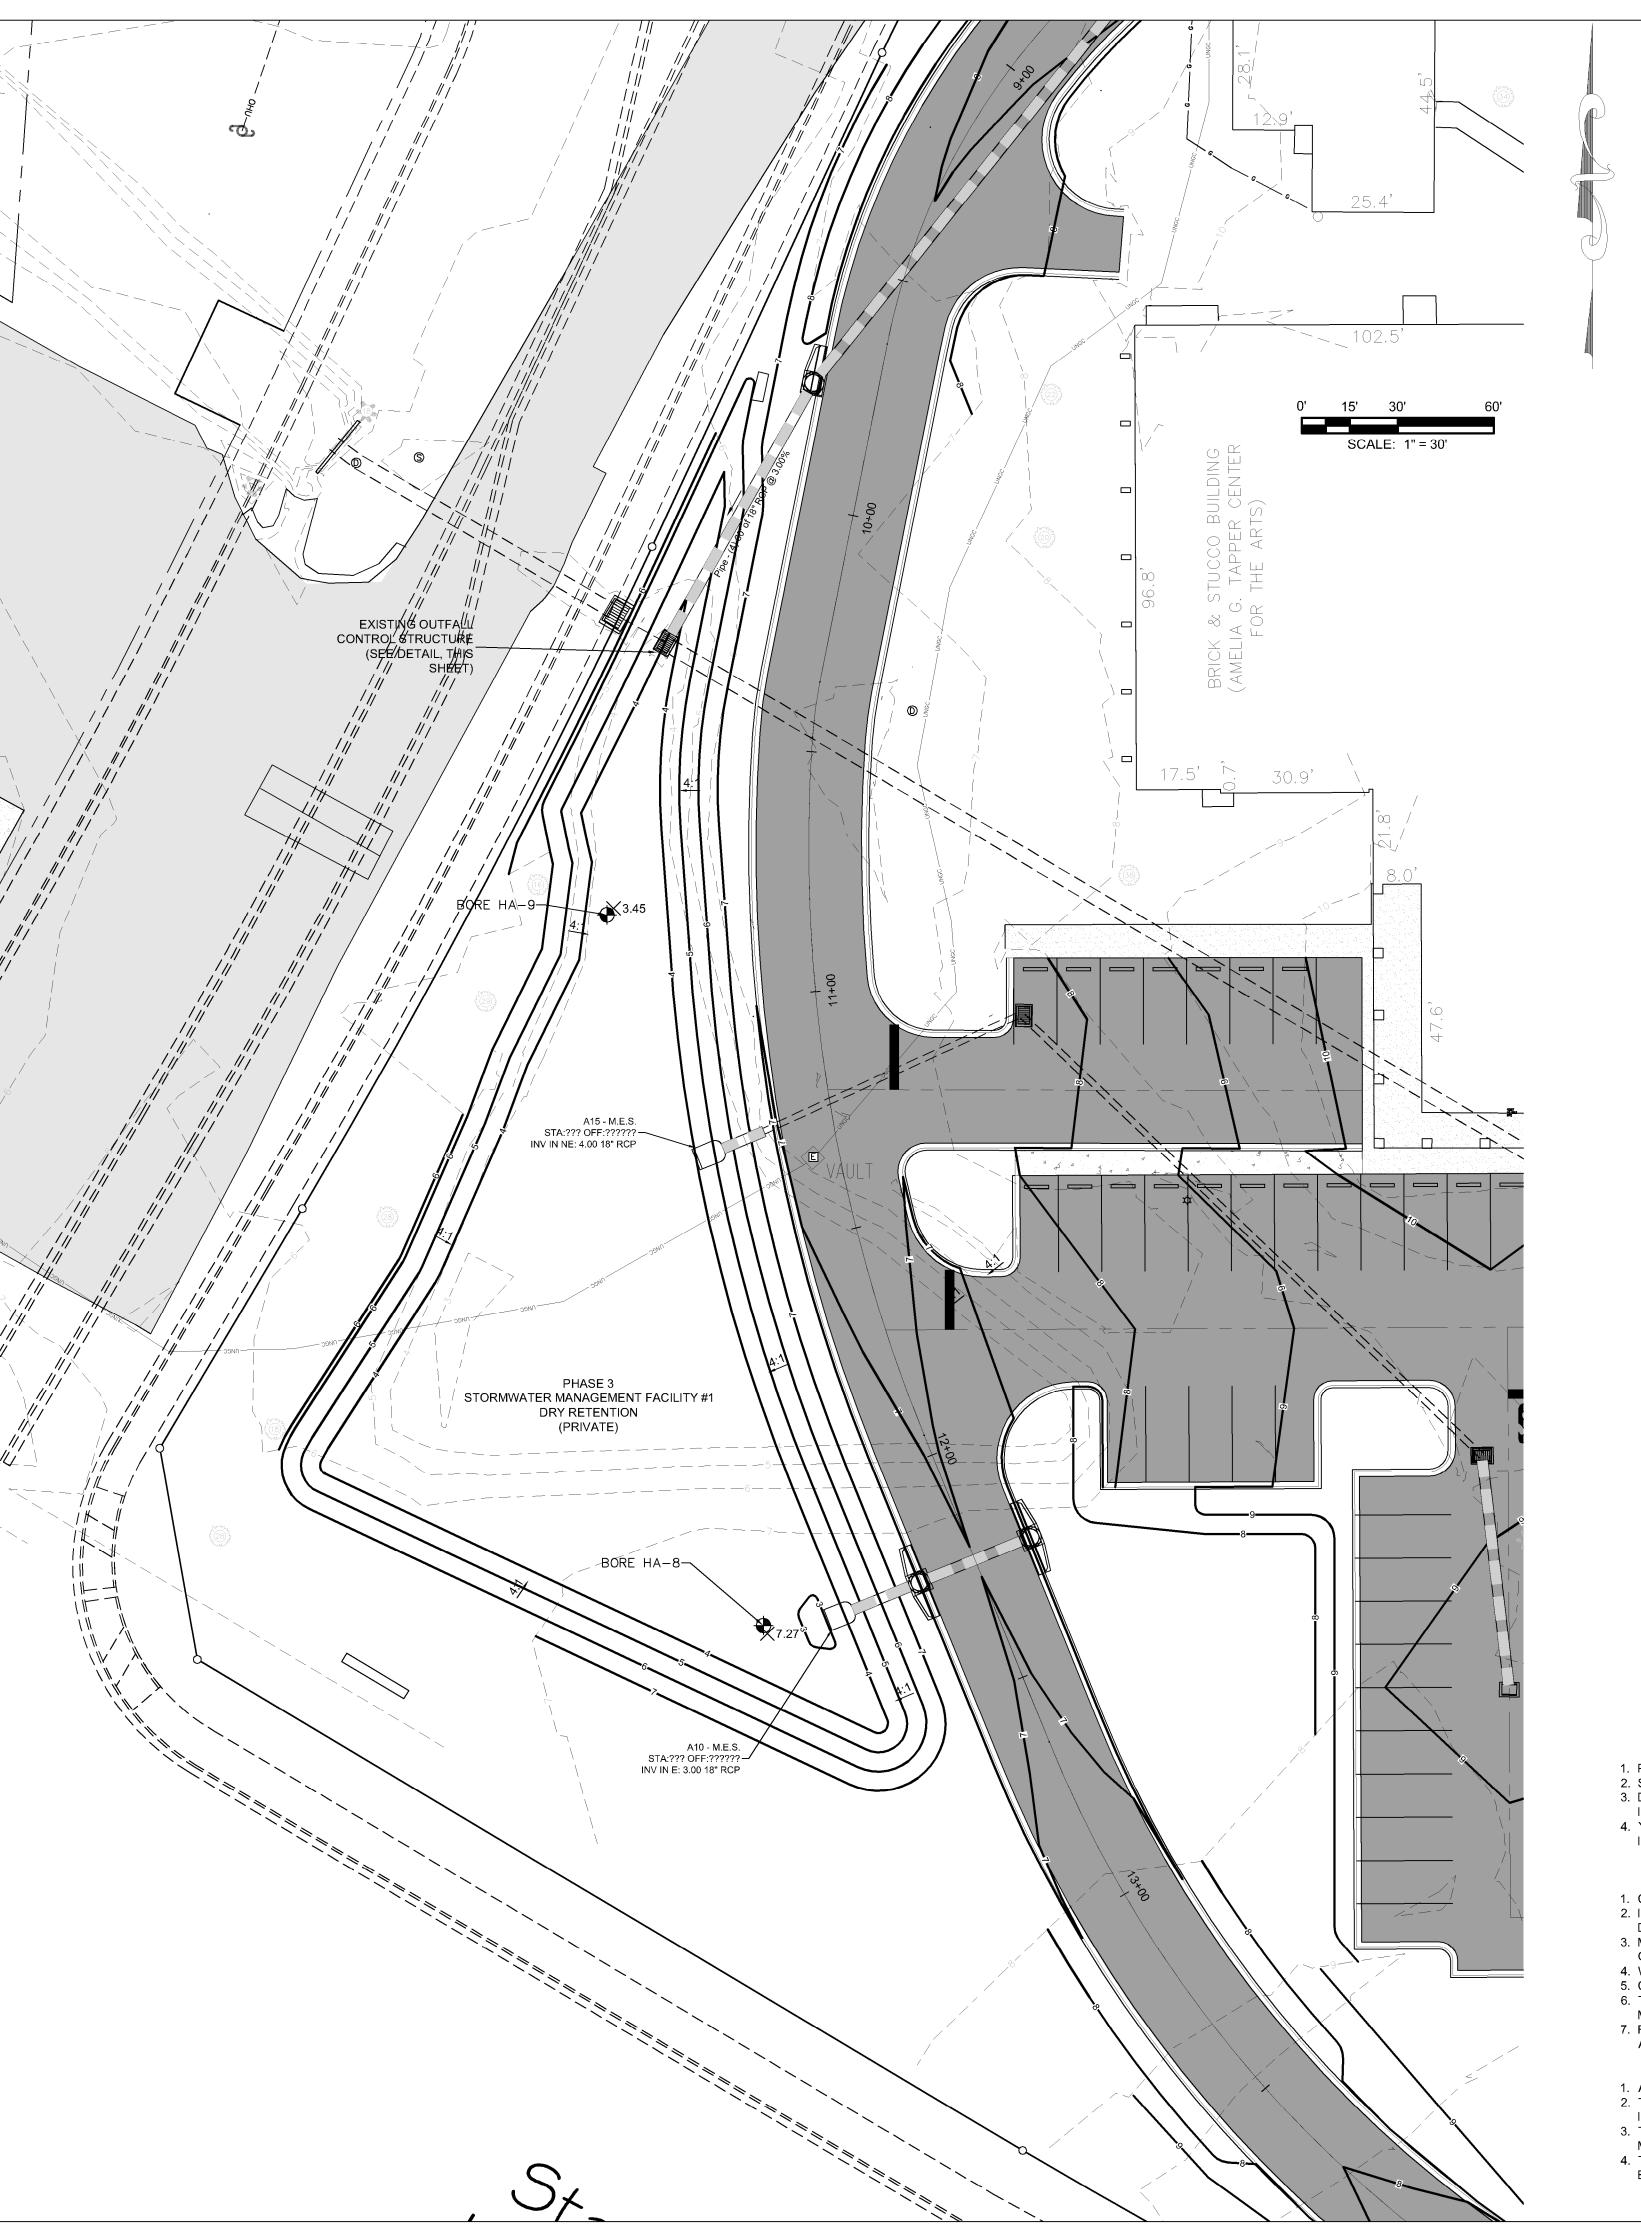

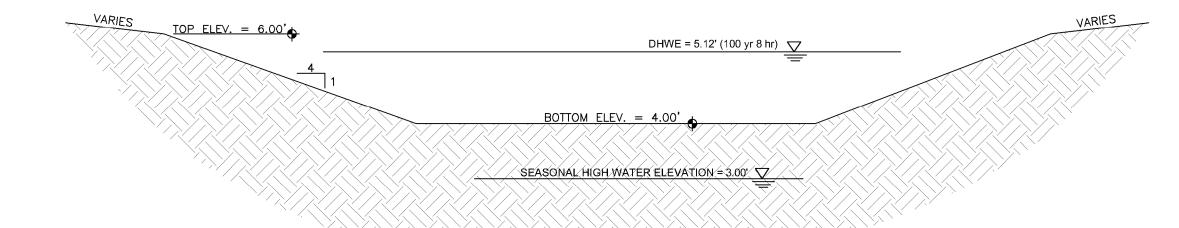


NOTE:

1. ALL POND SIDE SLOPE TO BE STABILIZED WITH SOD TO 2' BELOW PPE.

2. ALL OTHER DISTURBED AREAS TO BE STABILIZED WITH HYDROSEED OR SOD.

### **SECTION**

TYPICAL POND SECTION

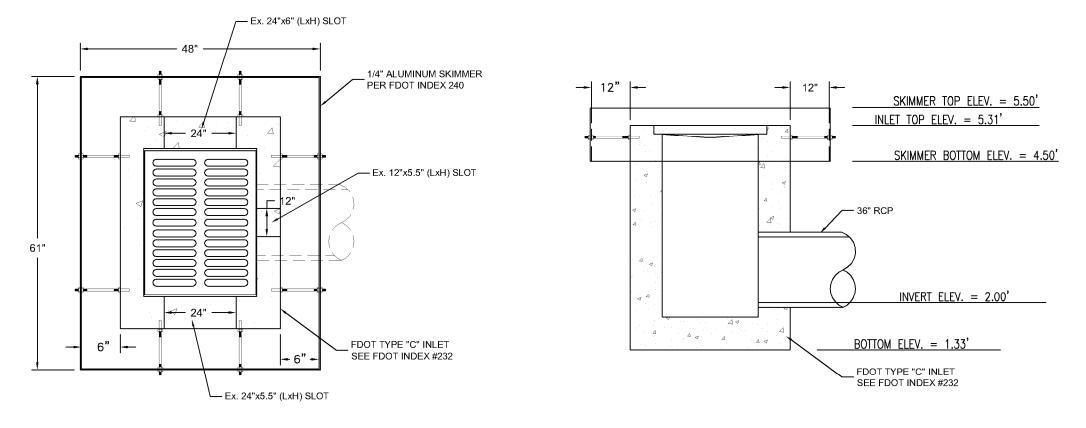

<u>Plan view</u>

SECTION VIEW

**DETAIL** CONCRETE DISCHARGE STRUCTURE (TYPE C)

### STORMWATER OPERATION/MAINTENANCE PLAN OPERATION AND MAINTENANCE ENTITY IS D.R HORTON INC.

#### AFTER EACH RAINFALL EVENT

- 1. PAVEMENT AREAS CLEAN/SWEEP DEBRIS AND DIRT FROM PAVEMENT AREAS. 2. SEDIMENTS IN RETENTION/DETENTION AREAS – REMOVED IMMEDIATELY.
- 3. DEBRIS IN RETENTION/DETENTION AREAS ALL DEBRIS AND FOREIGN MATERIAL SHALL BE REMOVED
- 4. YARD INLETS, CATCH BASINS, ETC. ALL DEBRIS AND FOREIGN MATERIALS SHALL BE REMOVED IMMEDIATELY.

#### PERIODIC POND/SYSTEM MAINTENANCE

- CLEANING/SWEEPING OF PAVEMENT AREAS SHALL BE ACCOMPLISHED WEEKLY OR AS REQUIRED.
   INSPECT POND PERIODICALLY FOR ACCUMULATION OF TRASH AND DEBRIS AND REMOVE IT UPON
- 3. MOWING AND LANDSCAPING MAINTENANCE SHOULD BE DONE ON A MONTHLY BASIS DURING THE ACTIVE GROWING SEASON FOR THE AREA. INSPECT AND MAINTAIN AS REQUIRED DURING THE GROWING SEASON.
- 4. WEEDS OR UNDESIRABLE GROWTH SHALL BE REMOVED UPON DISCOVERY.
- 5. CATCH BASINS SHALL BE FLUSHED AS NECESSARY (IF ANY). 6. THE OWNER SHALL RE-GRADE AND RE-STABILIZE SWALE/RETENTION/DETENTION AREAS AS REQUIRED TO
- MAINTAIN THE APPROVED DESIGN, CROSS-SECTION, LINE, AND GRADE. 7. REMOVE SEDIMENT FROM POND WHEN ACCUMULATION REACHES FOUR (4) INCHES. MEASURE ACCUMULATION ONCE A YEAR.

#### <u>INSPECTIONS</u>

- A MAINTENANCE INSPECTION MUST BE PERFORMED EVERY THIRD YEAR BY A REGISTERED PROFESSIONAL.
   THE MAINTENANCE INSPECTION MUST BE DOCUMENTED ON THE FDEP AND/OR NWFWMD STANDARD
- BY THE FDEP AND/OR NWFWMD.

THE INSPECTION MUST BE SIGNED, SEALED, AND DATED BY THE REGISTERED PROFESSIONAL AND RECORDS MUST BE MADE AVAILABLE UPON REQUEST OF FDEP AND/OR NWFWMD.
 THE INSPECTION MUST BE CONDUCTED USING THE PLANS, CALCULATIONS AND SPECIFICATIONS APPROVED

LICENSE #AAOOO2730 648 Florida Avenue

P 850/257-5400

Panama City, Fl. 32401

JONATHAN SKLARSKI FL. P.E. 67361

> Principal in Charge Joseph J. Sorci Project Number: 4166-15


Date Issued: 5-4-2017 Drawn By: M.W. Checked By: J.S. Revisions:

BID No. ITB#8-2016/2017



COLLEGE IMPROVEMENT STATE COAST GULF

CONSTRUCTION DOCUMENTS

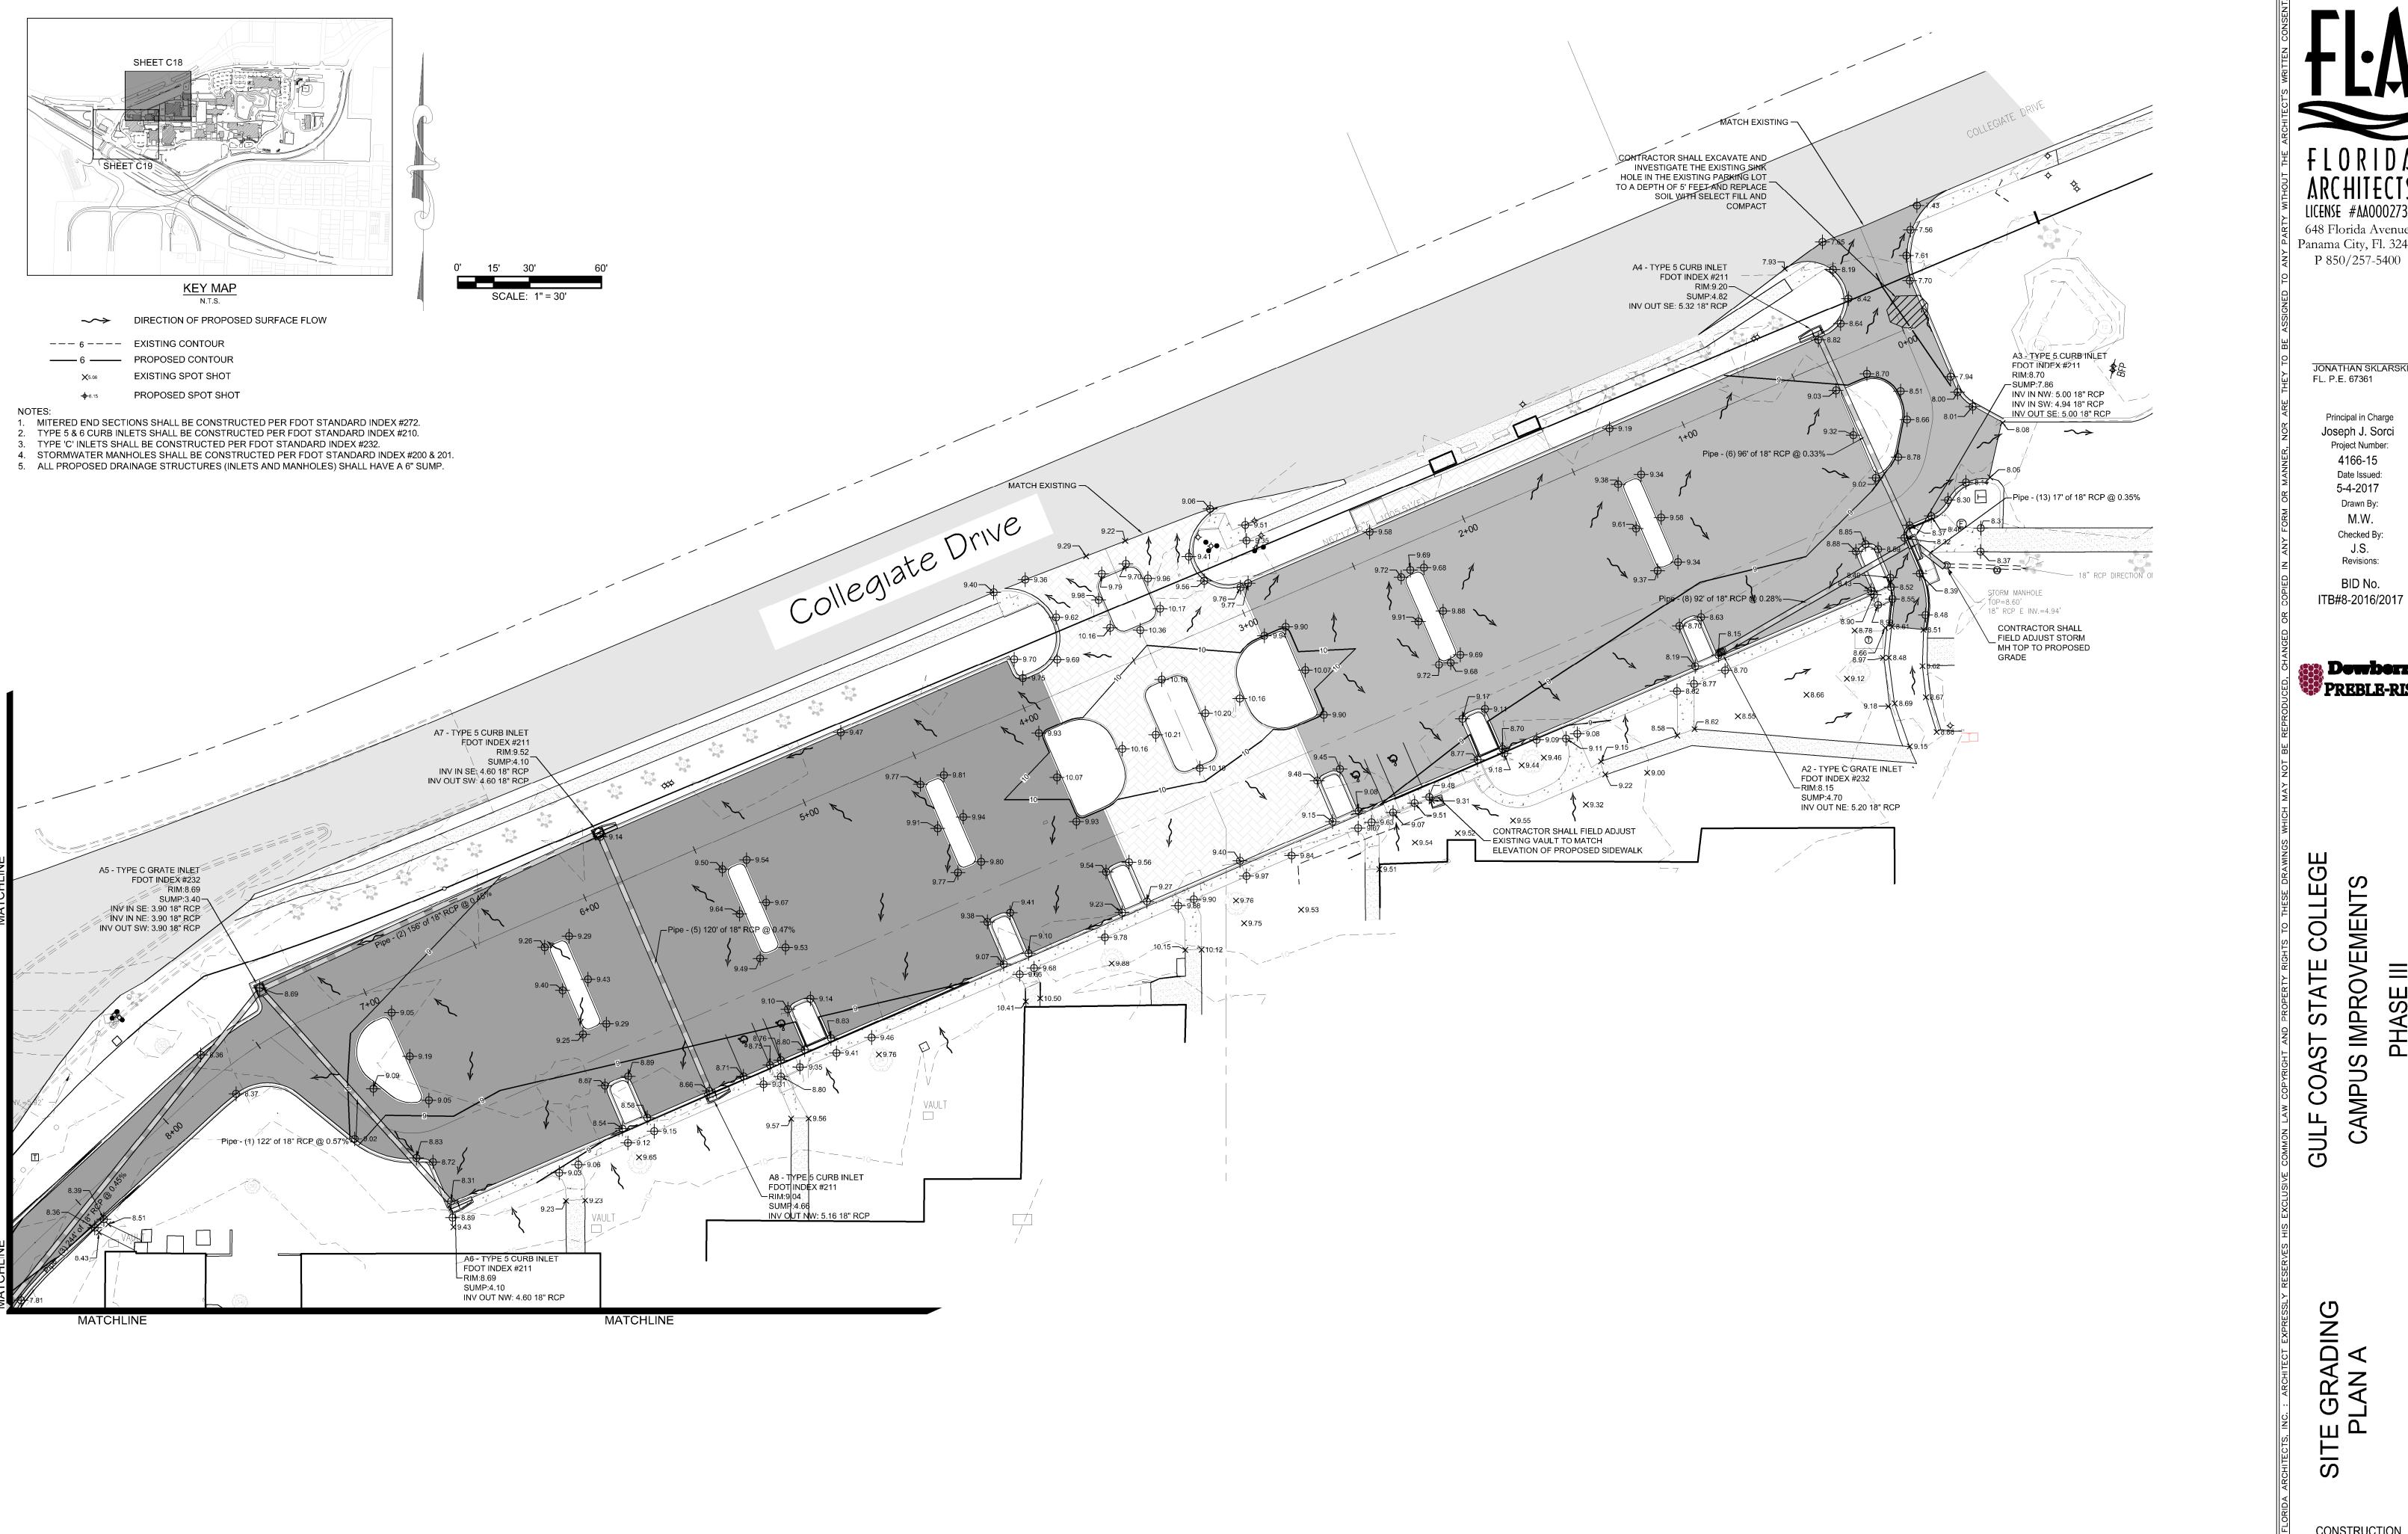

LICENSE #AA0002730 648 Florida Avenue Panama City, Fl. 32401

> JONATHAN SKLARSKI FL. P.E. 67361

Principal in Charge Joseph J. Sorci Project Number: 4166-15

Date Issued: 5-4-2017 Drawn By: M.W. Checked By: J.S. Revisions:


BID No. ITB#8-2016/2017




CAMPUS IMPROVEMENTS


SITE GRADING PLAN A

CONSTRUCTION DOCUMENTS

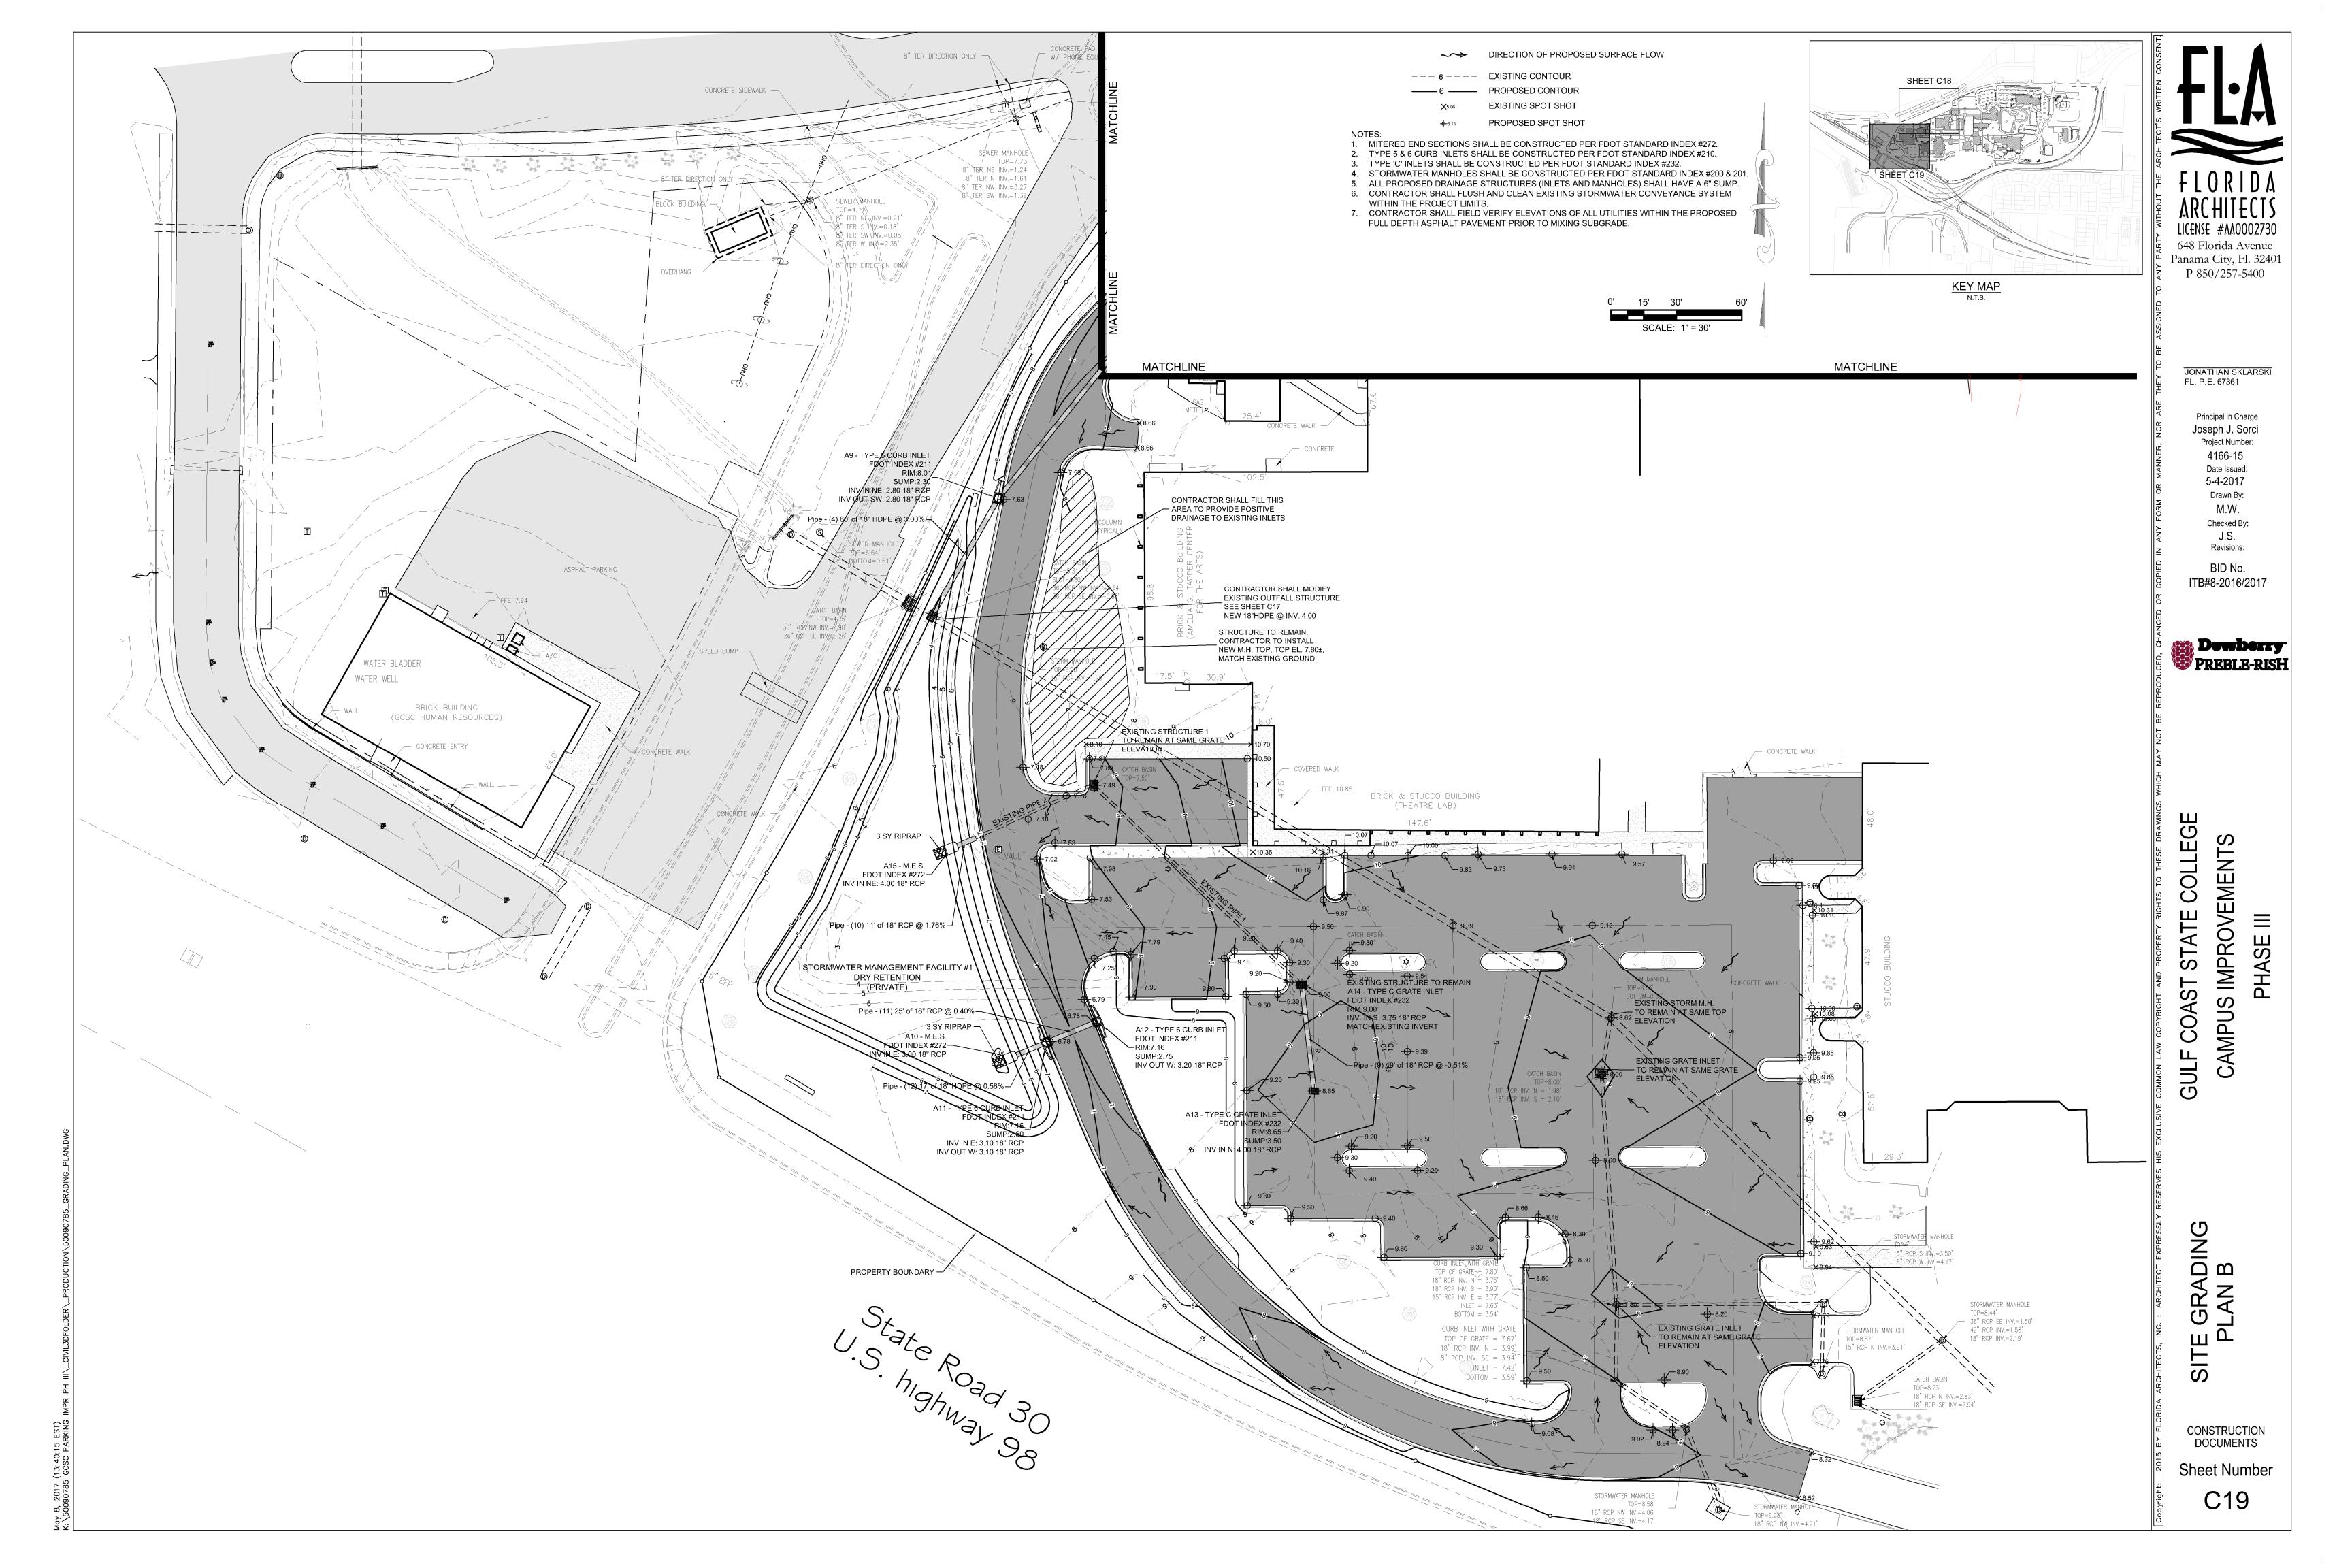


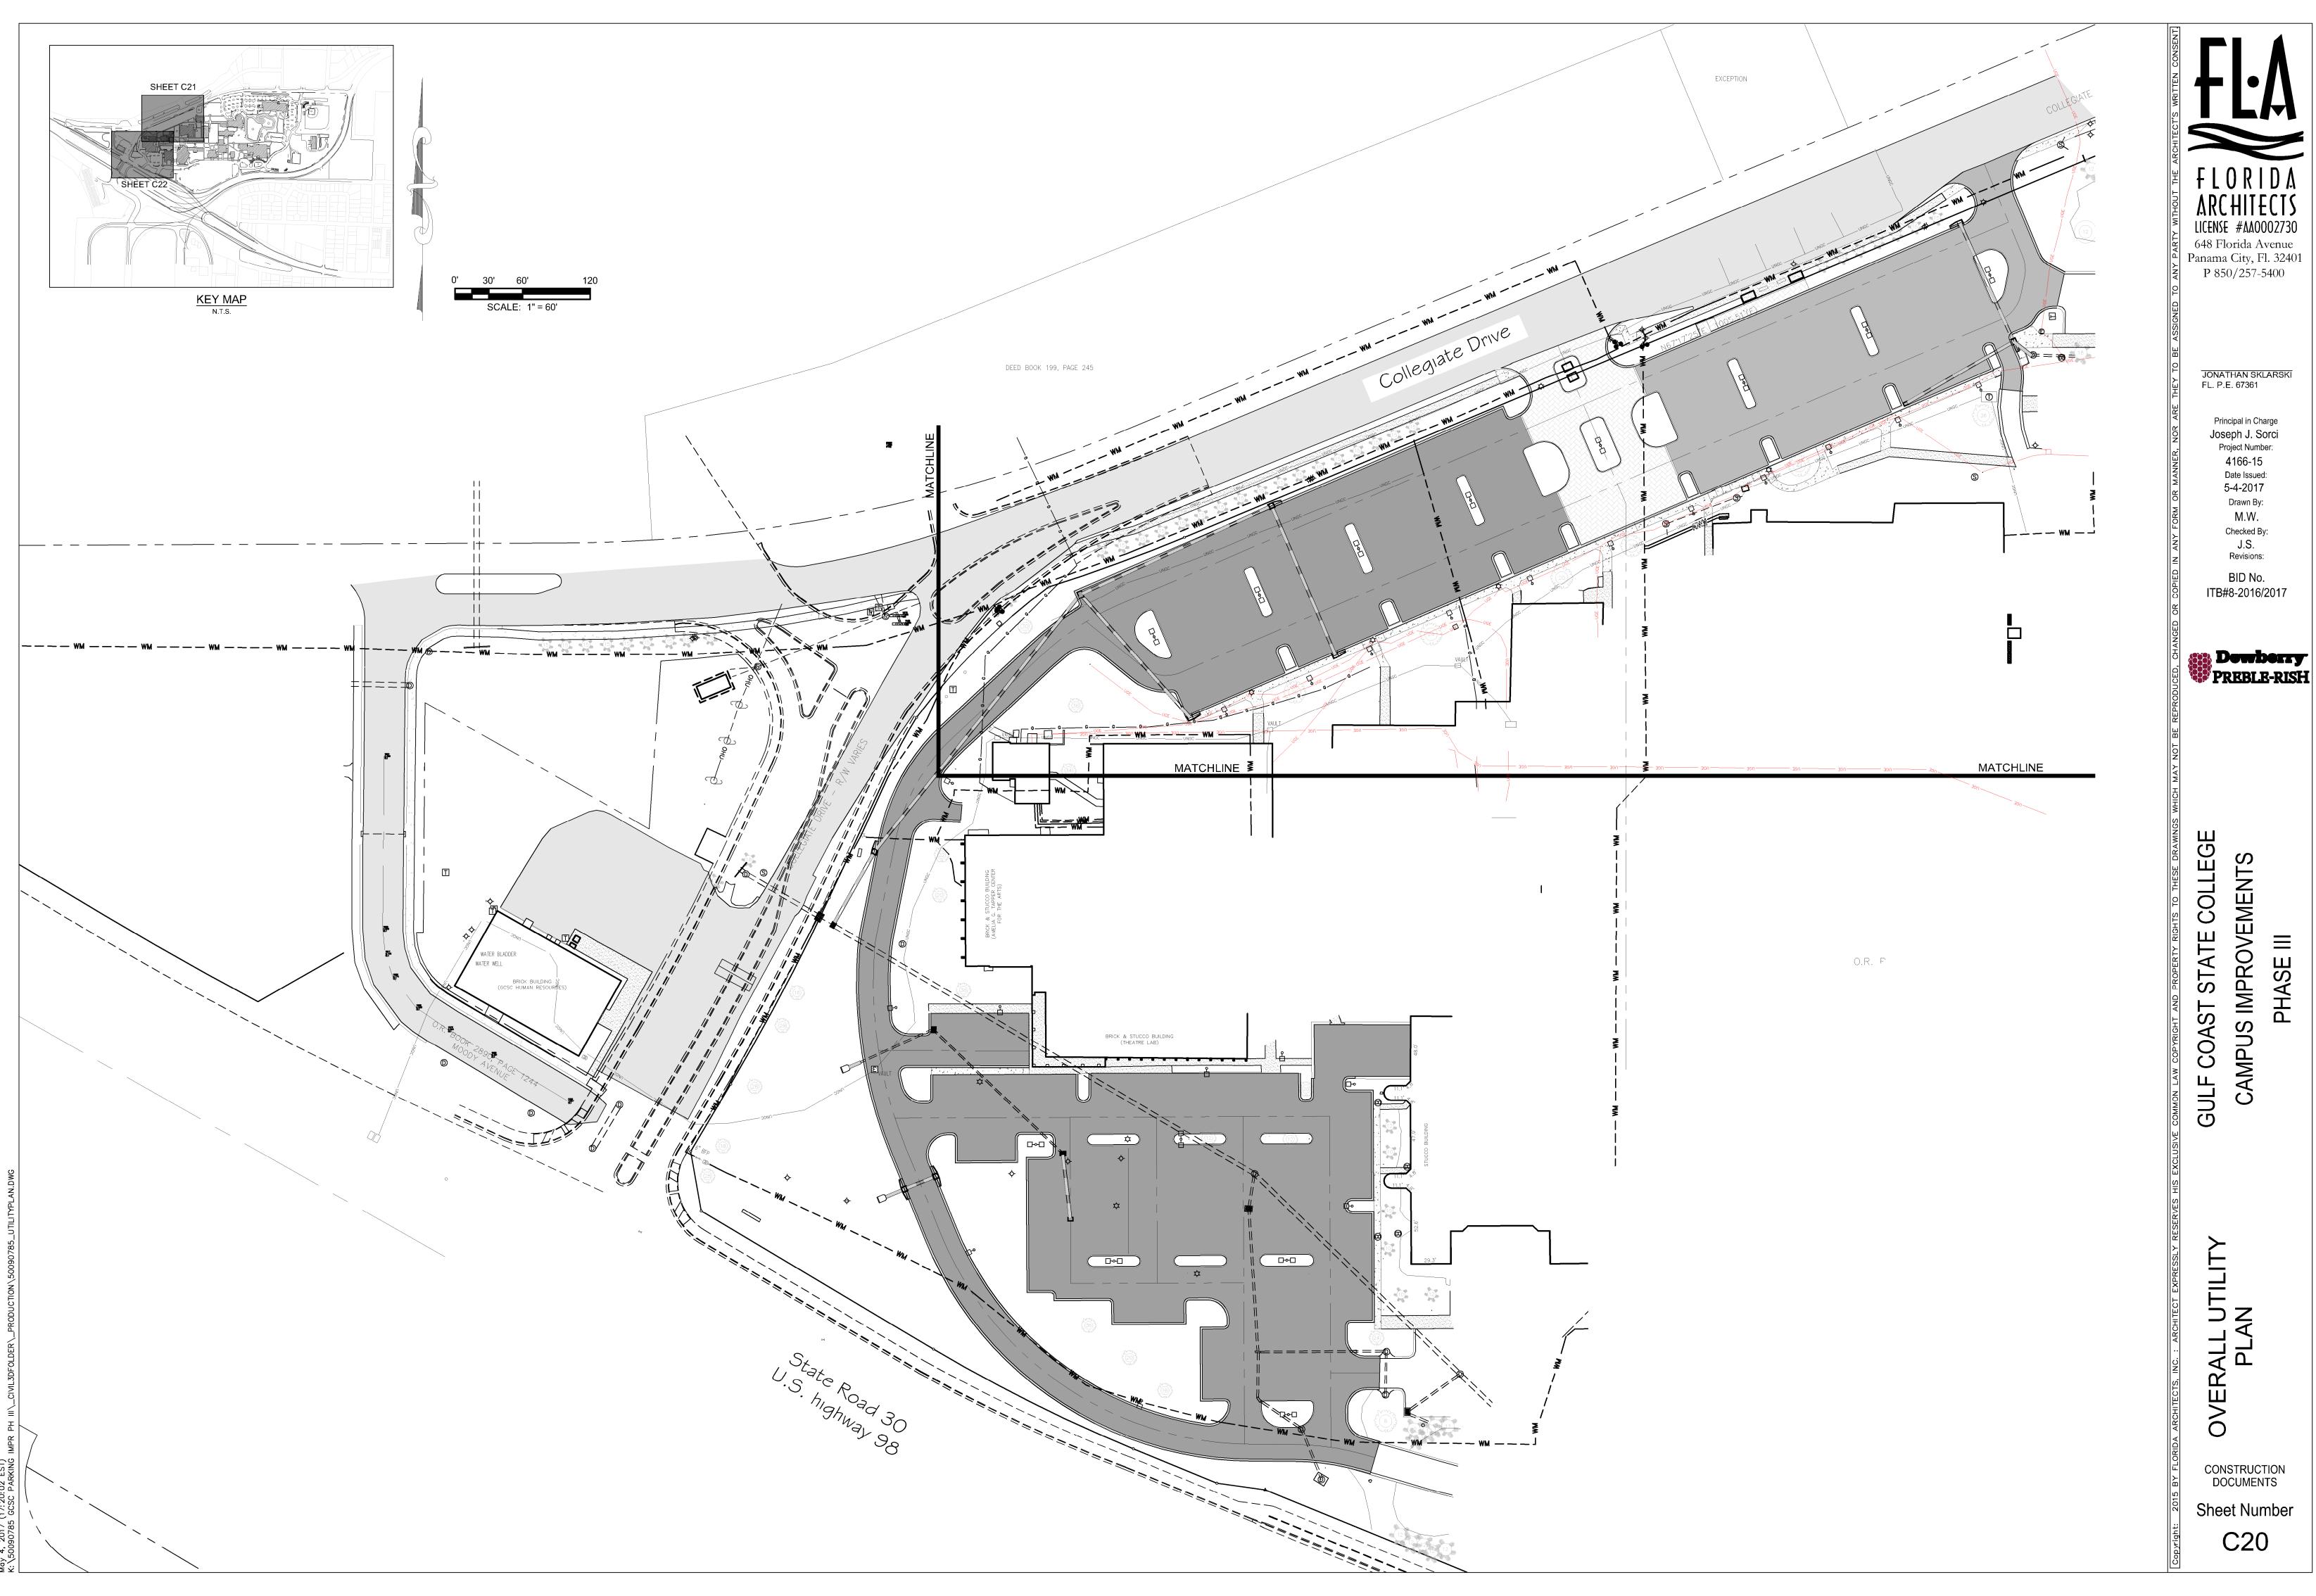




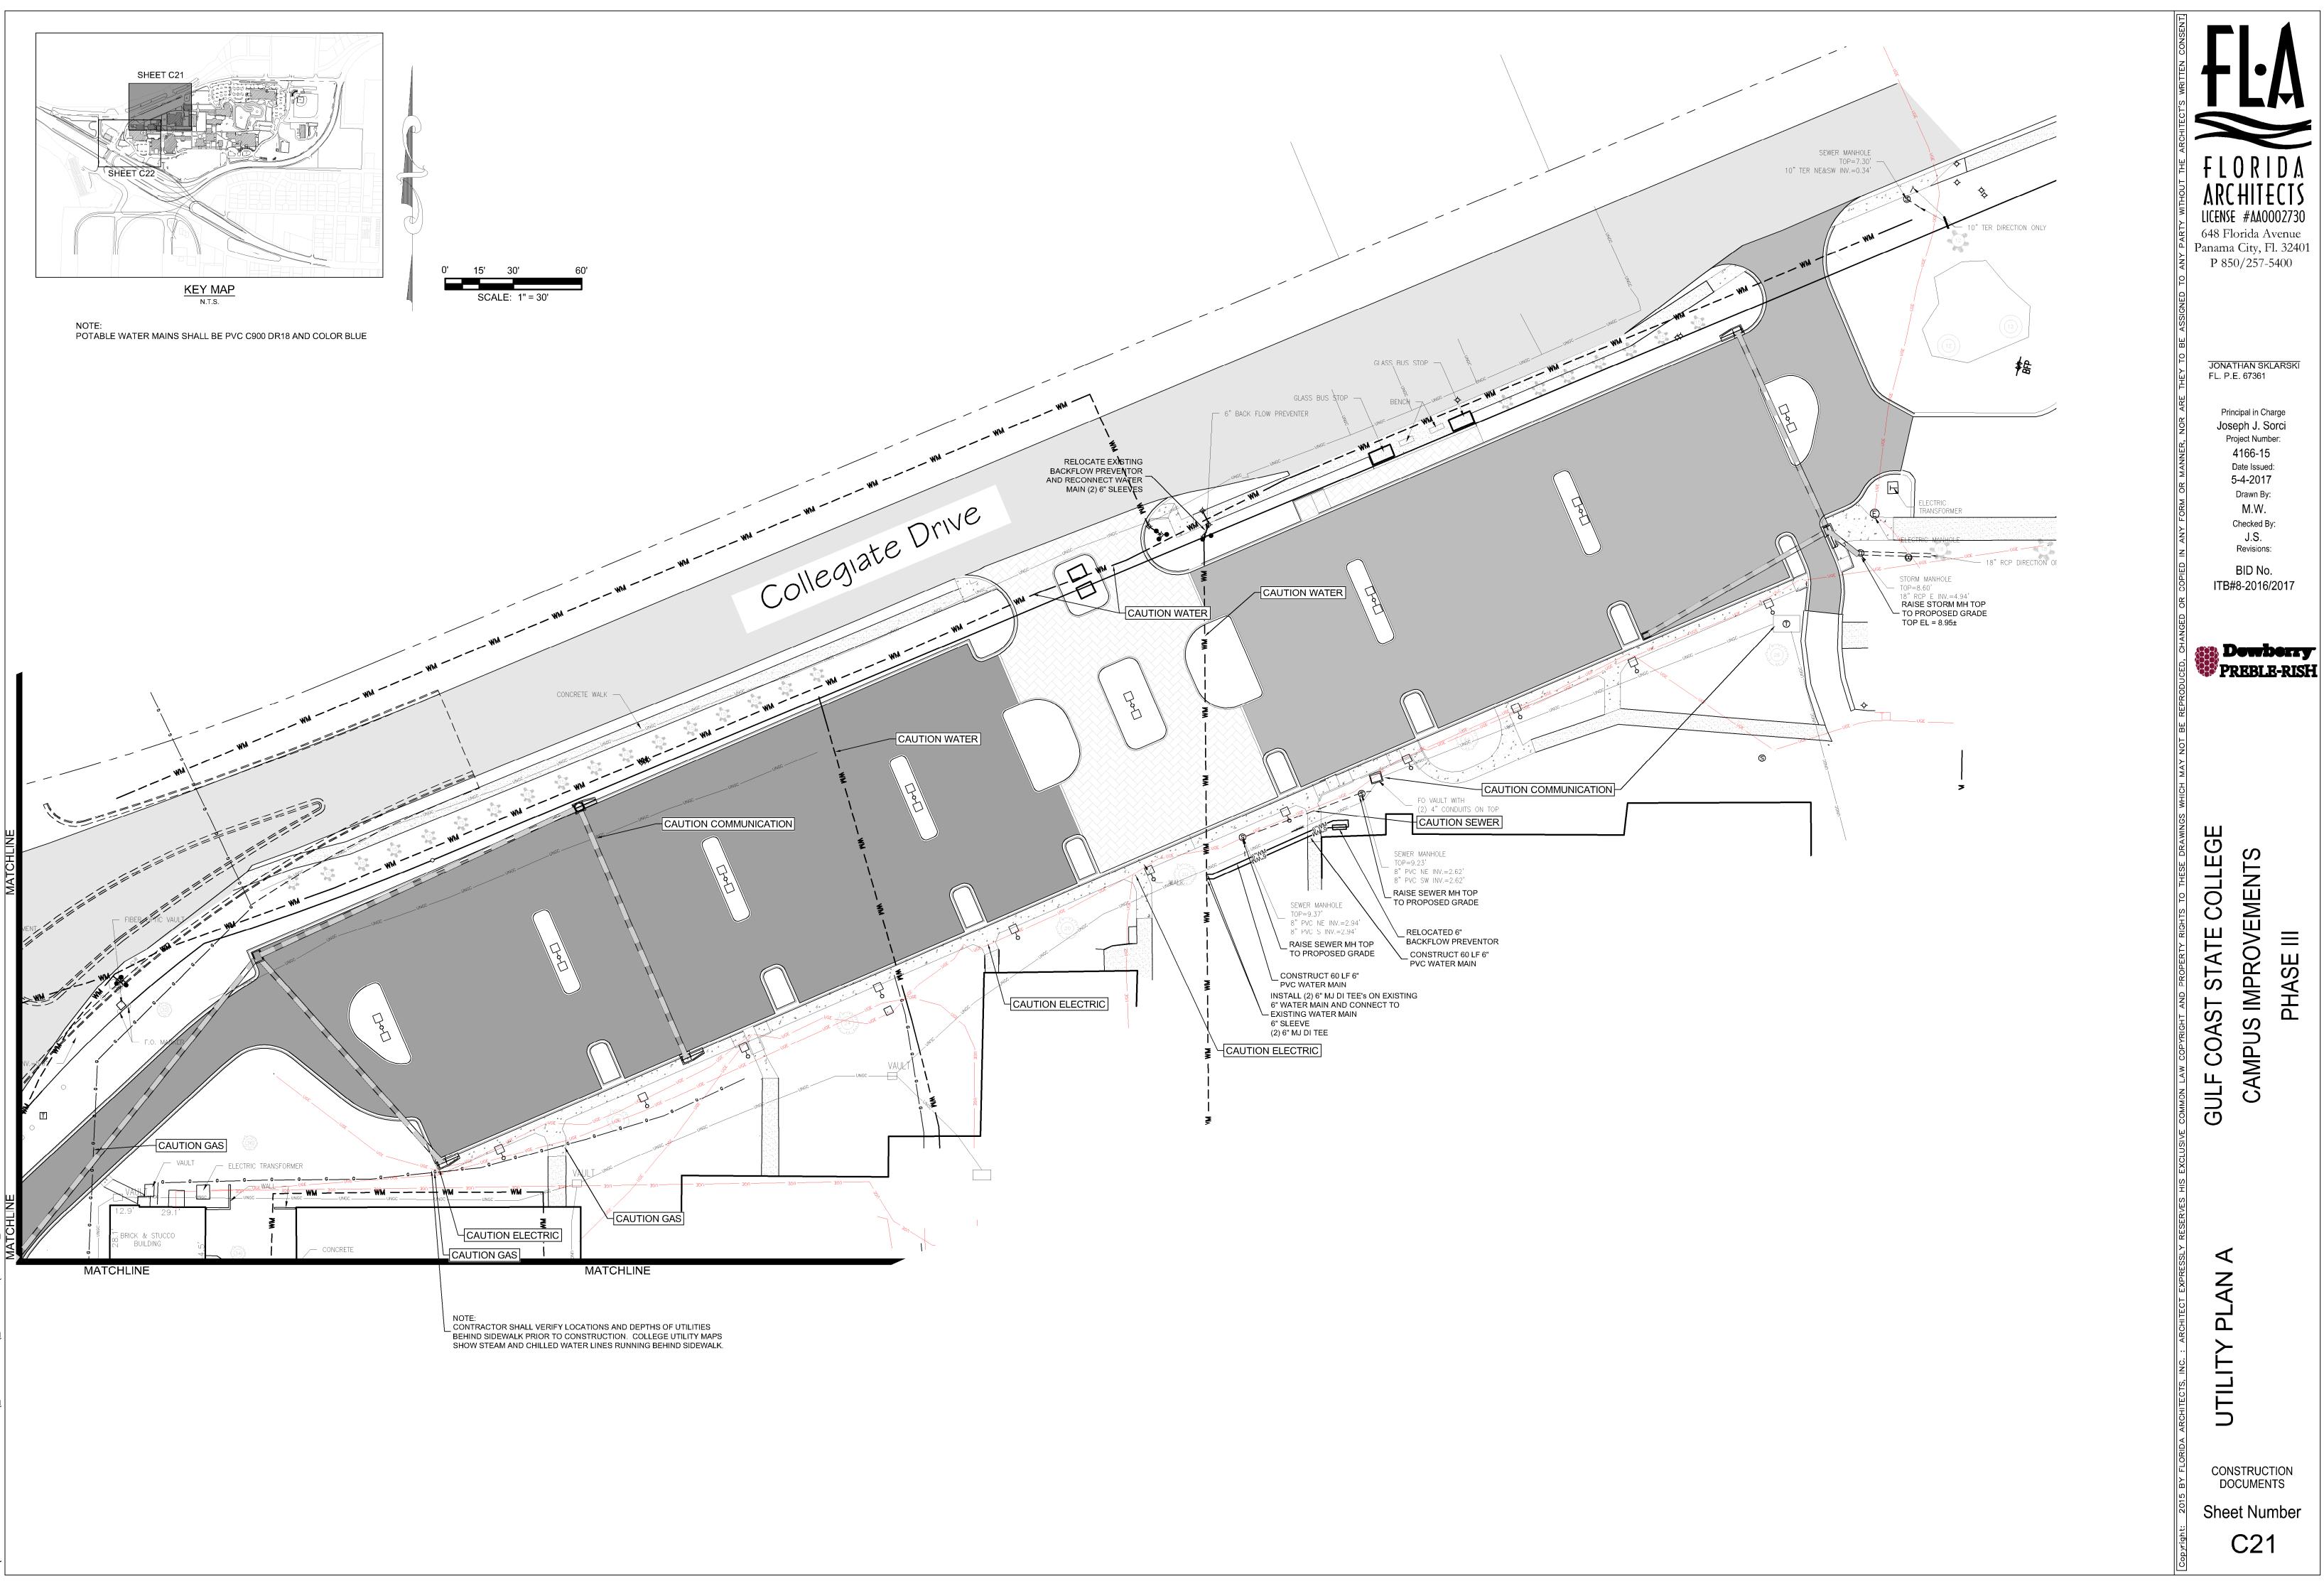





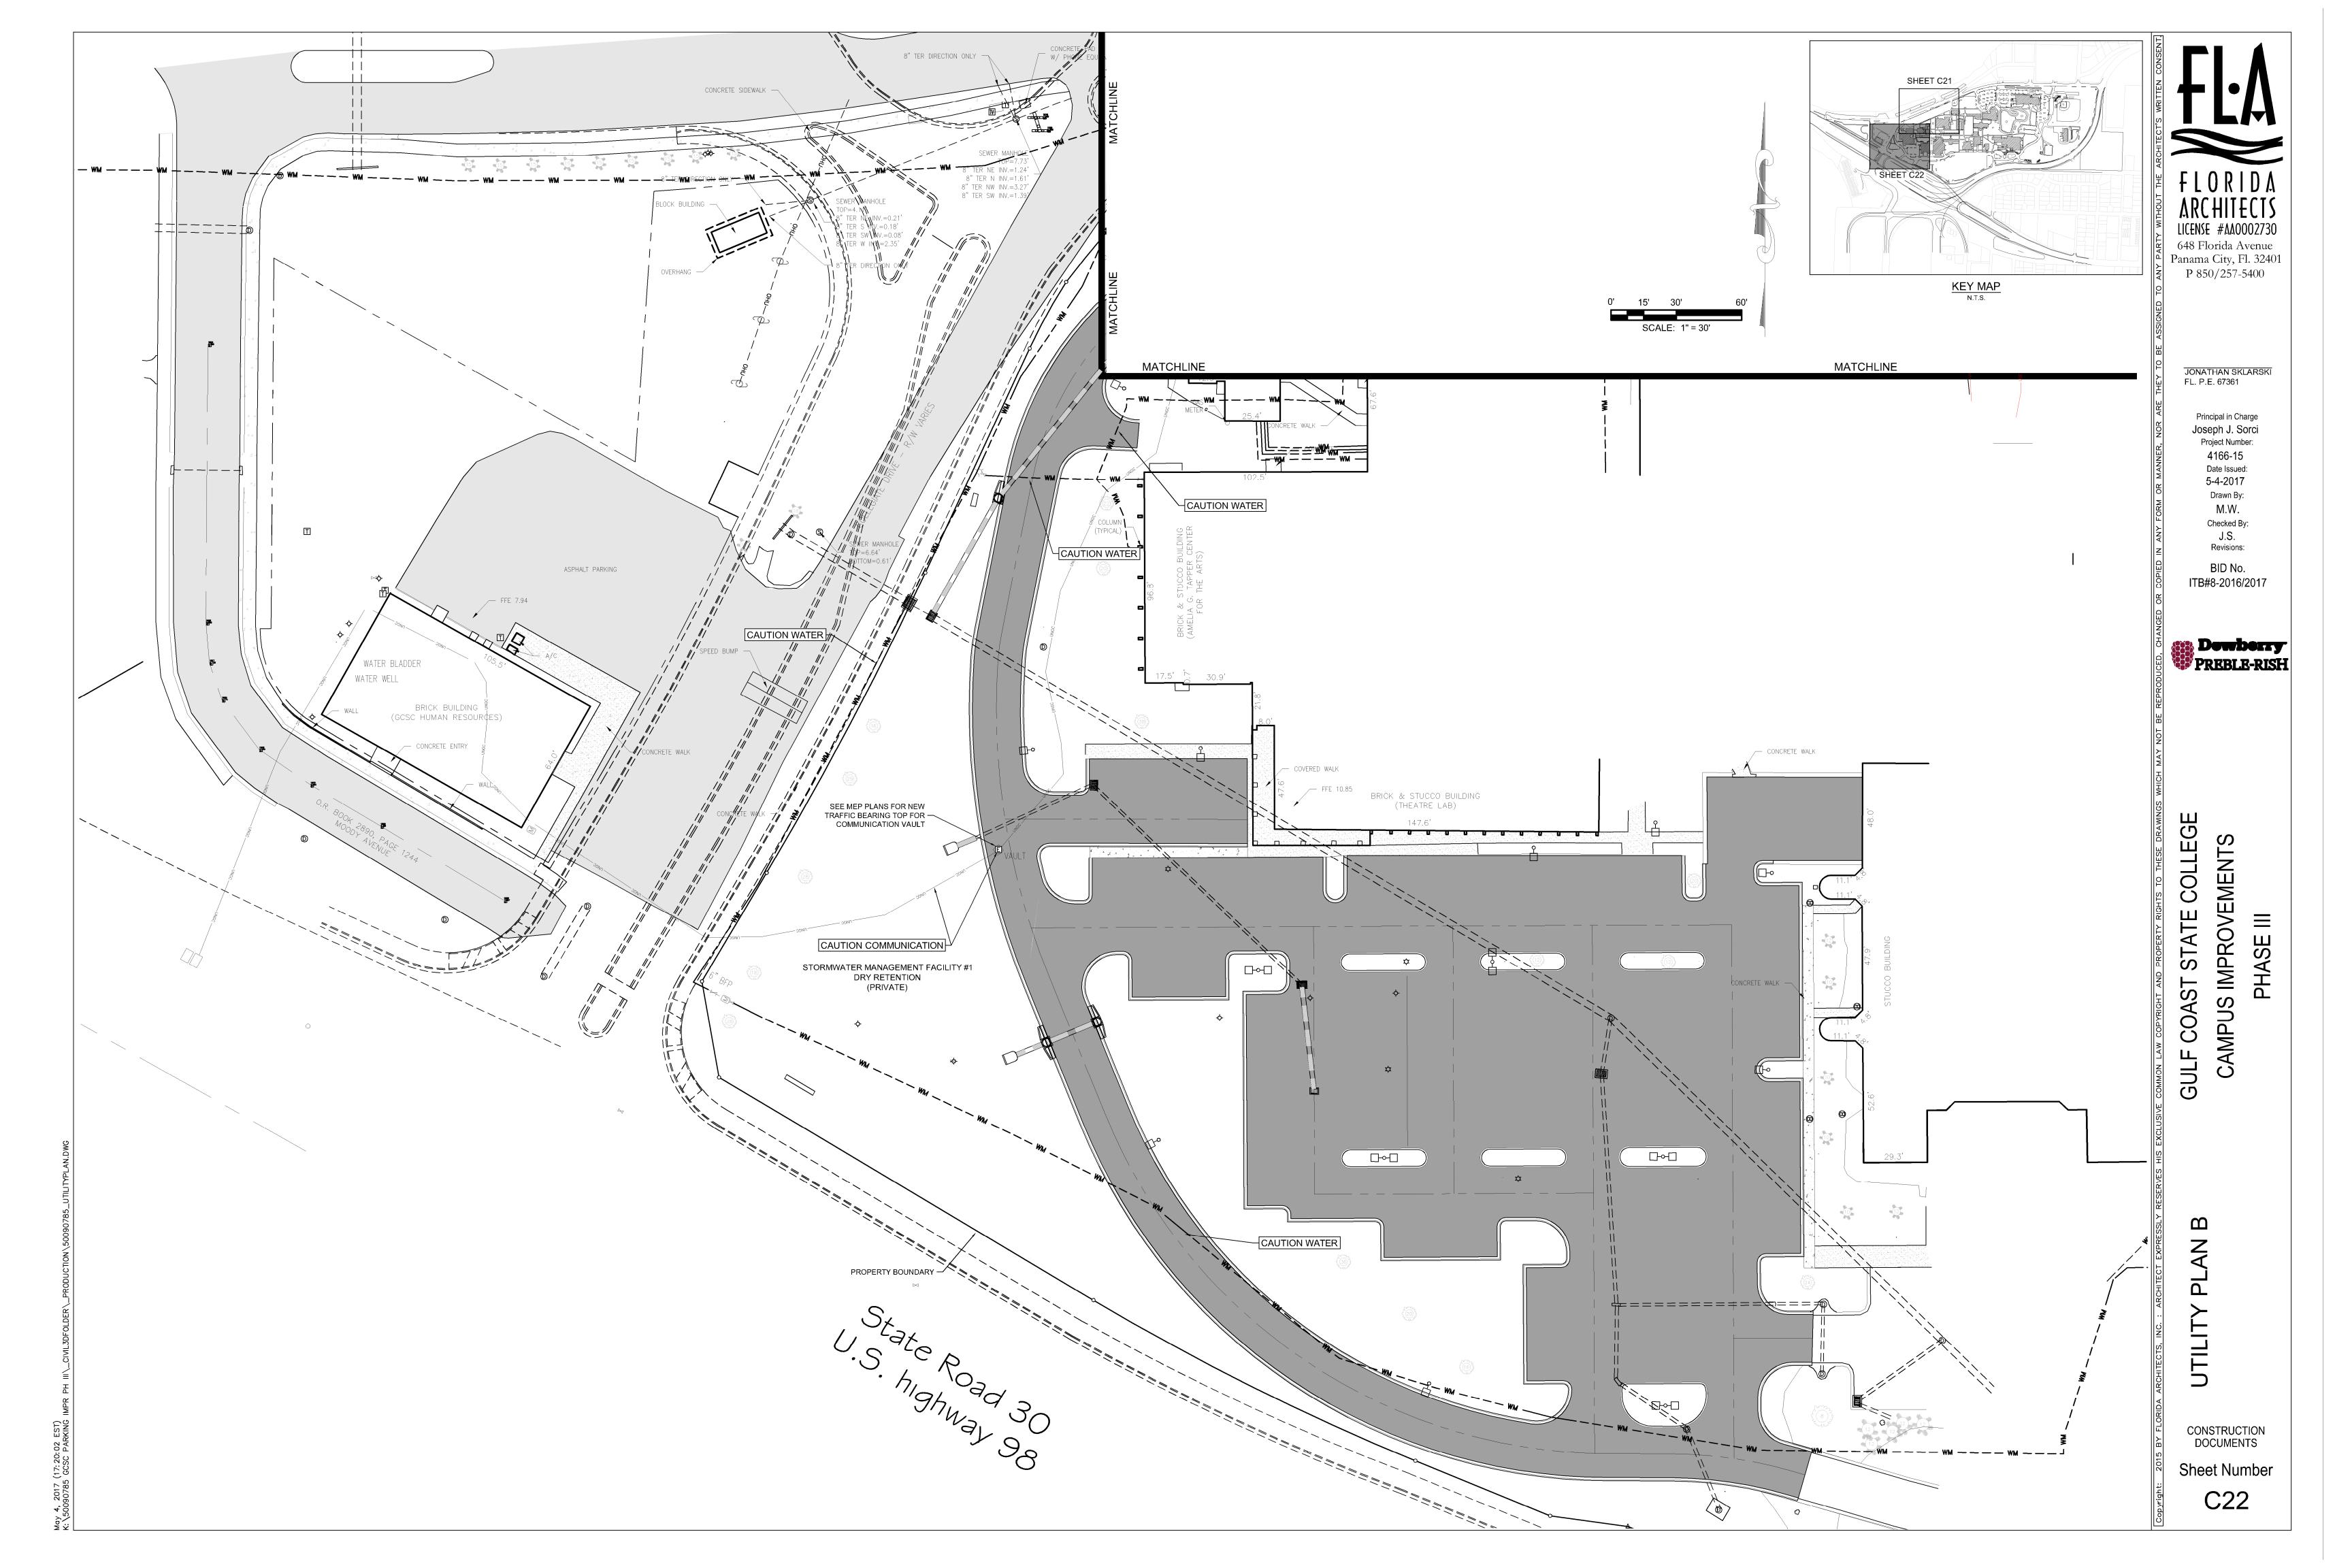

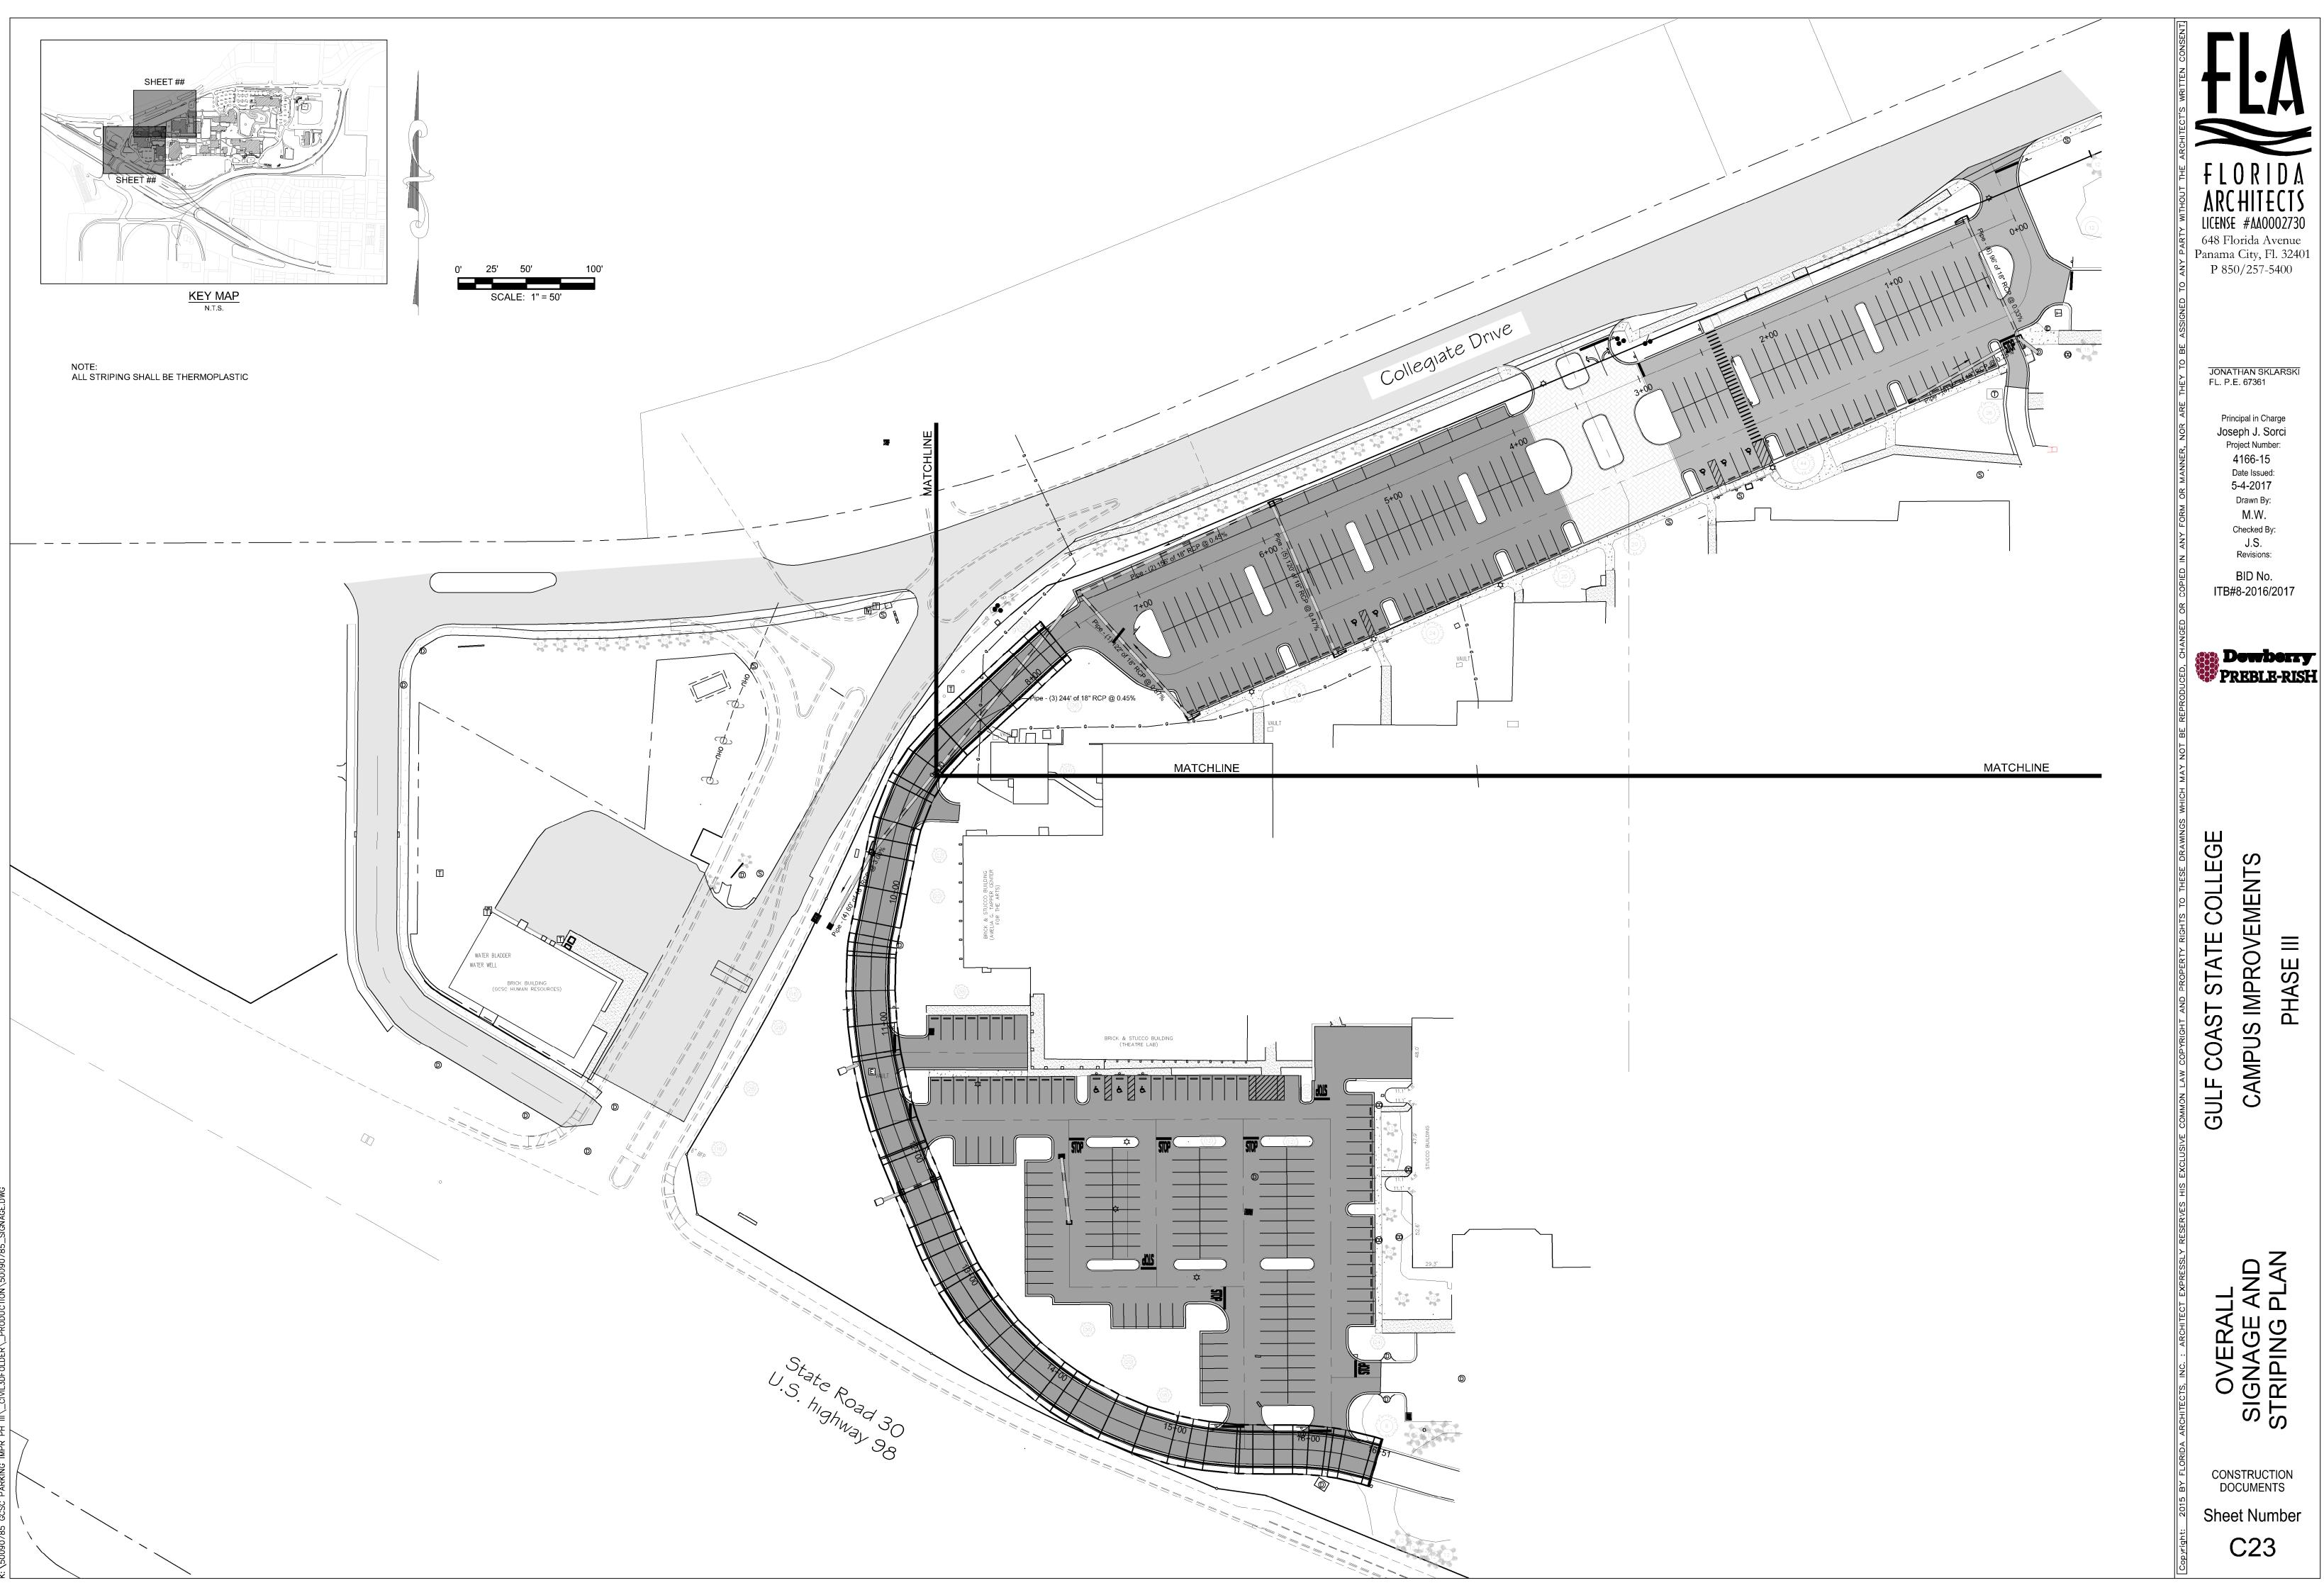



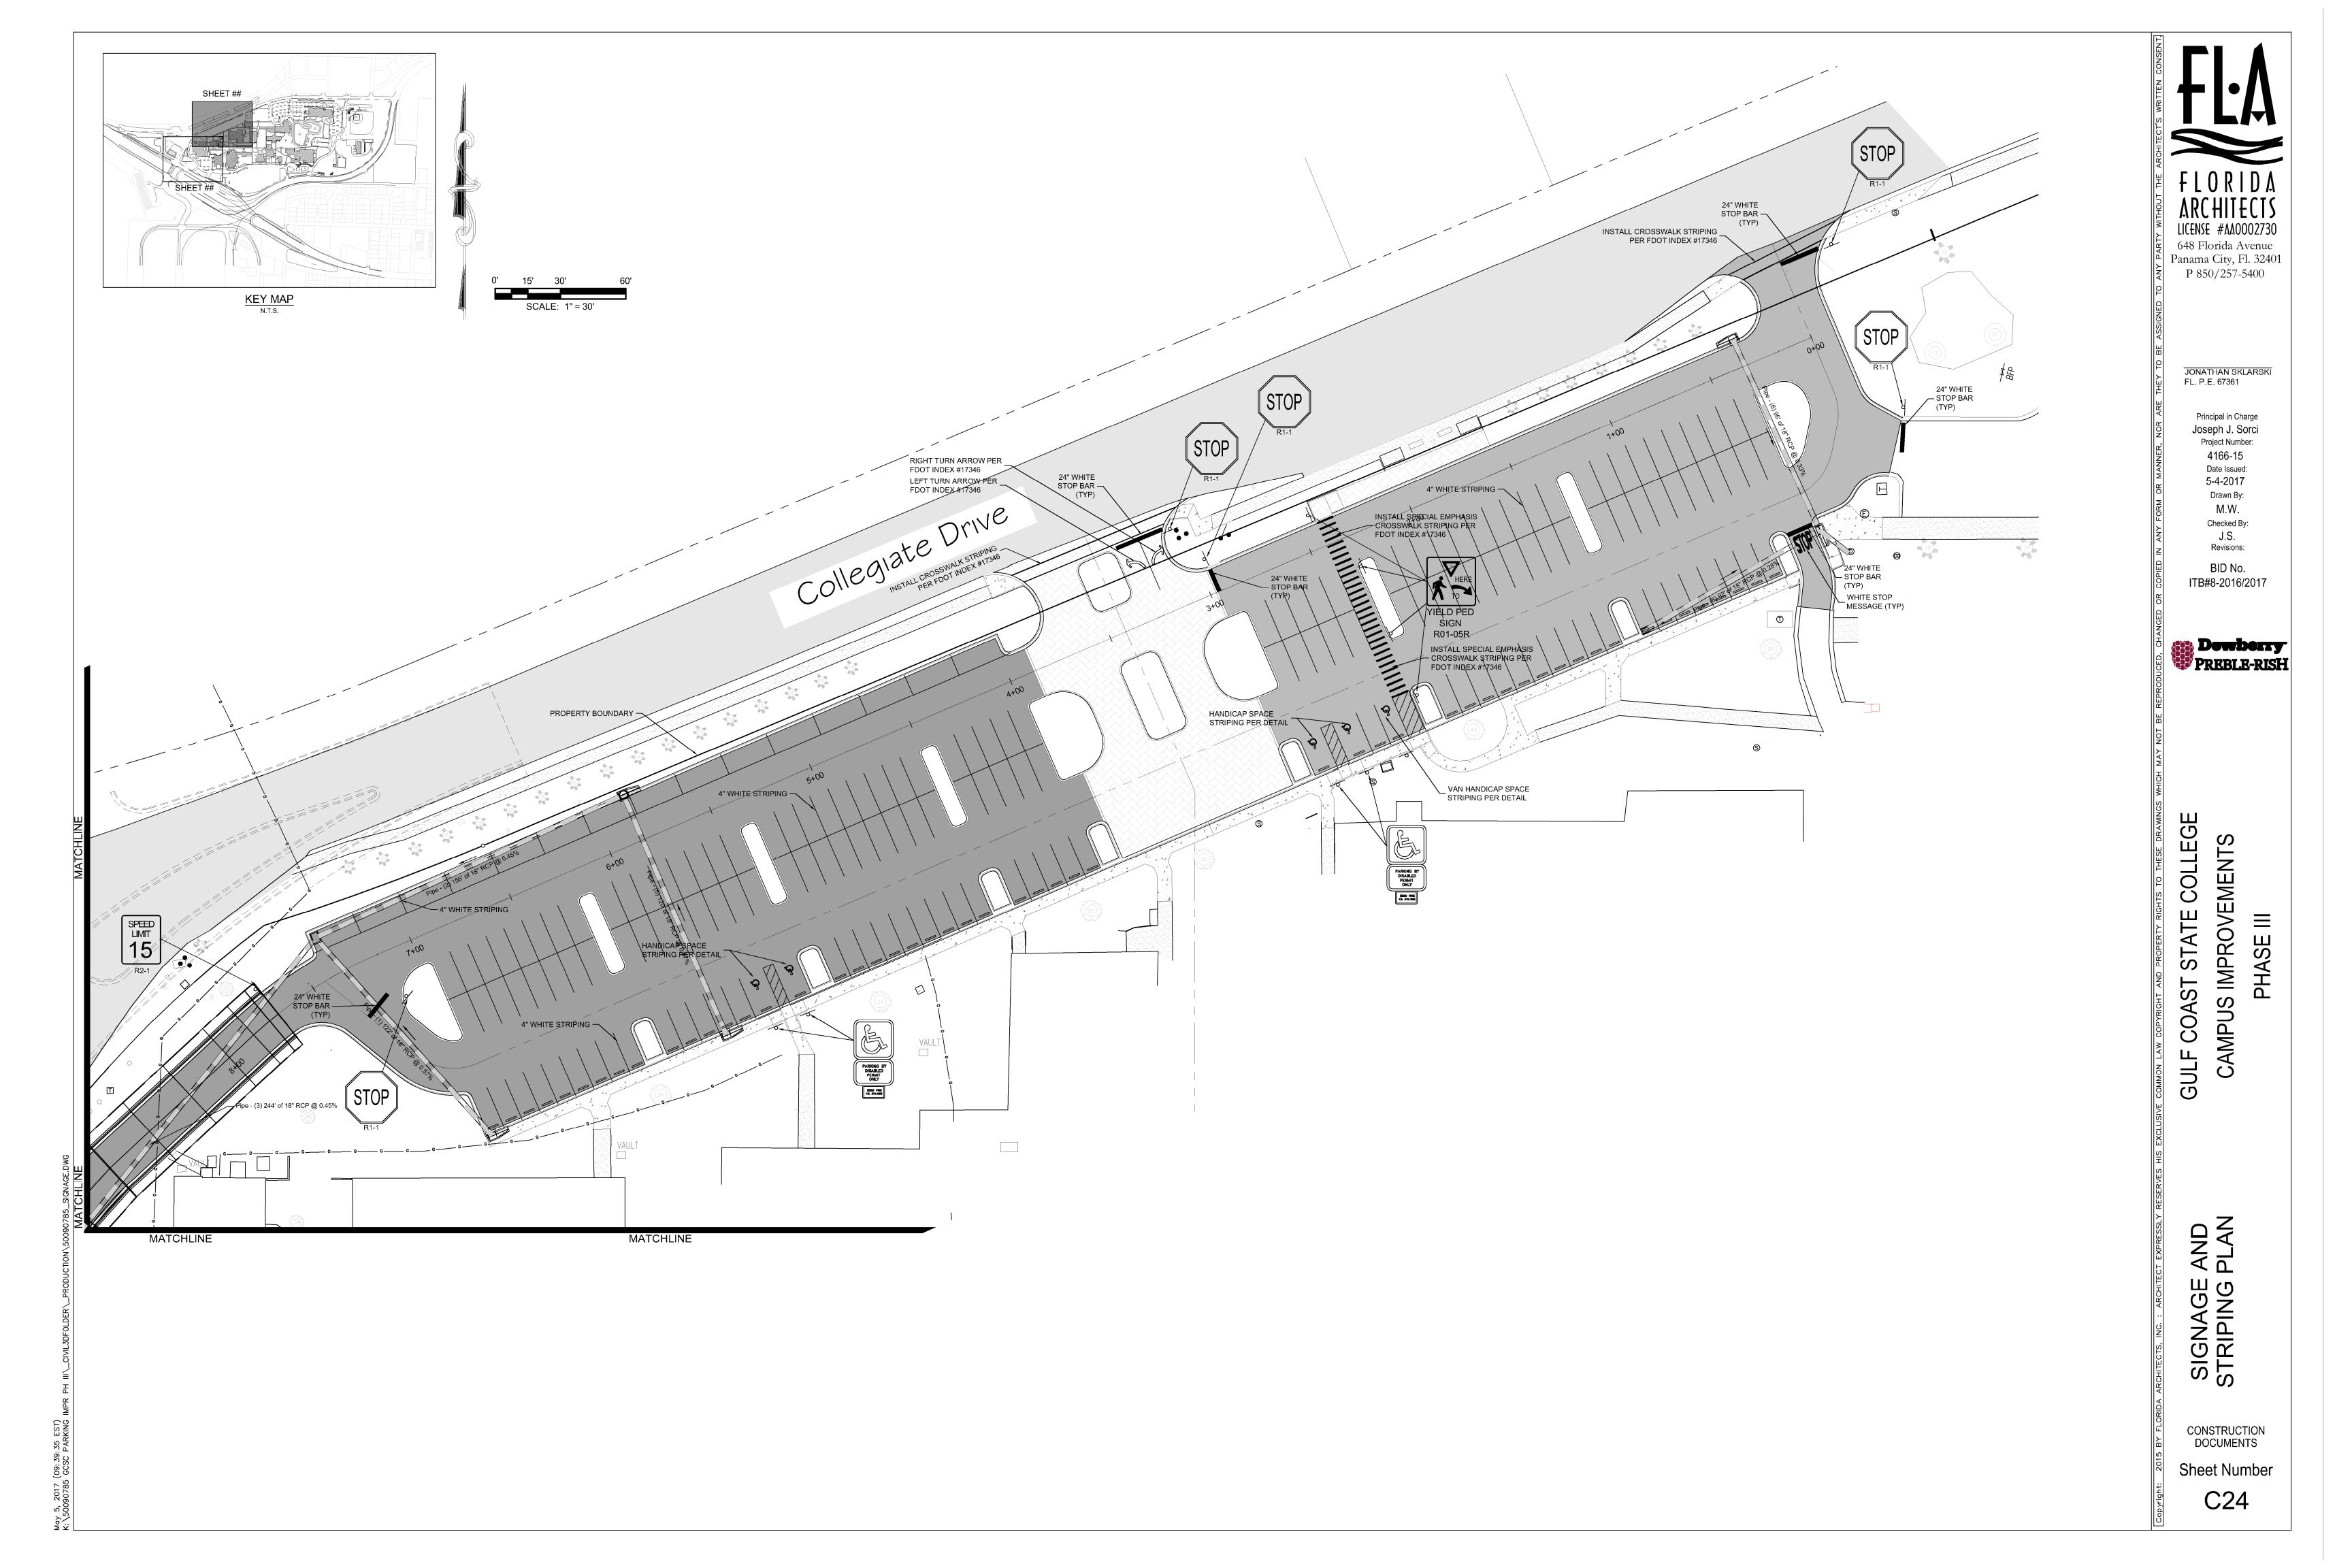


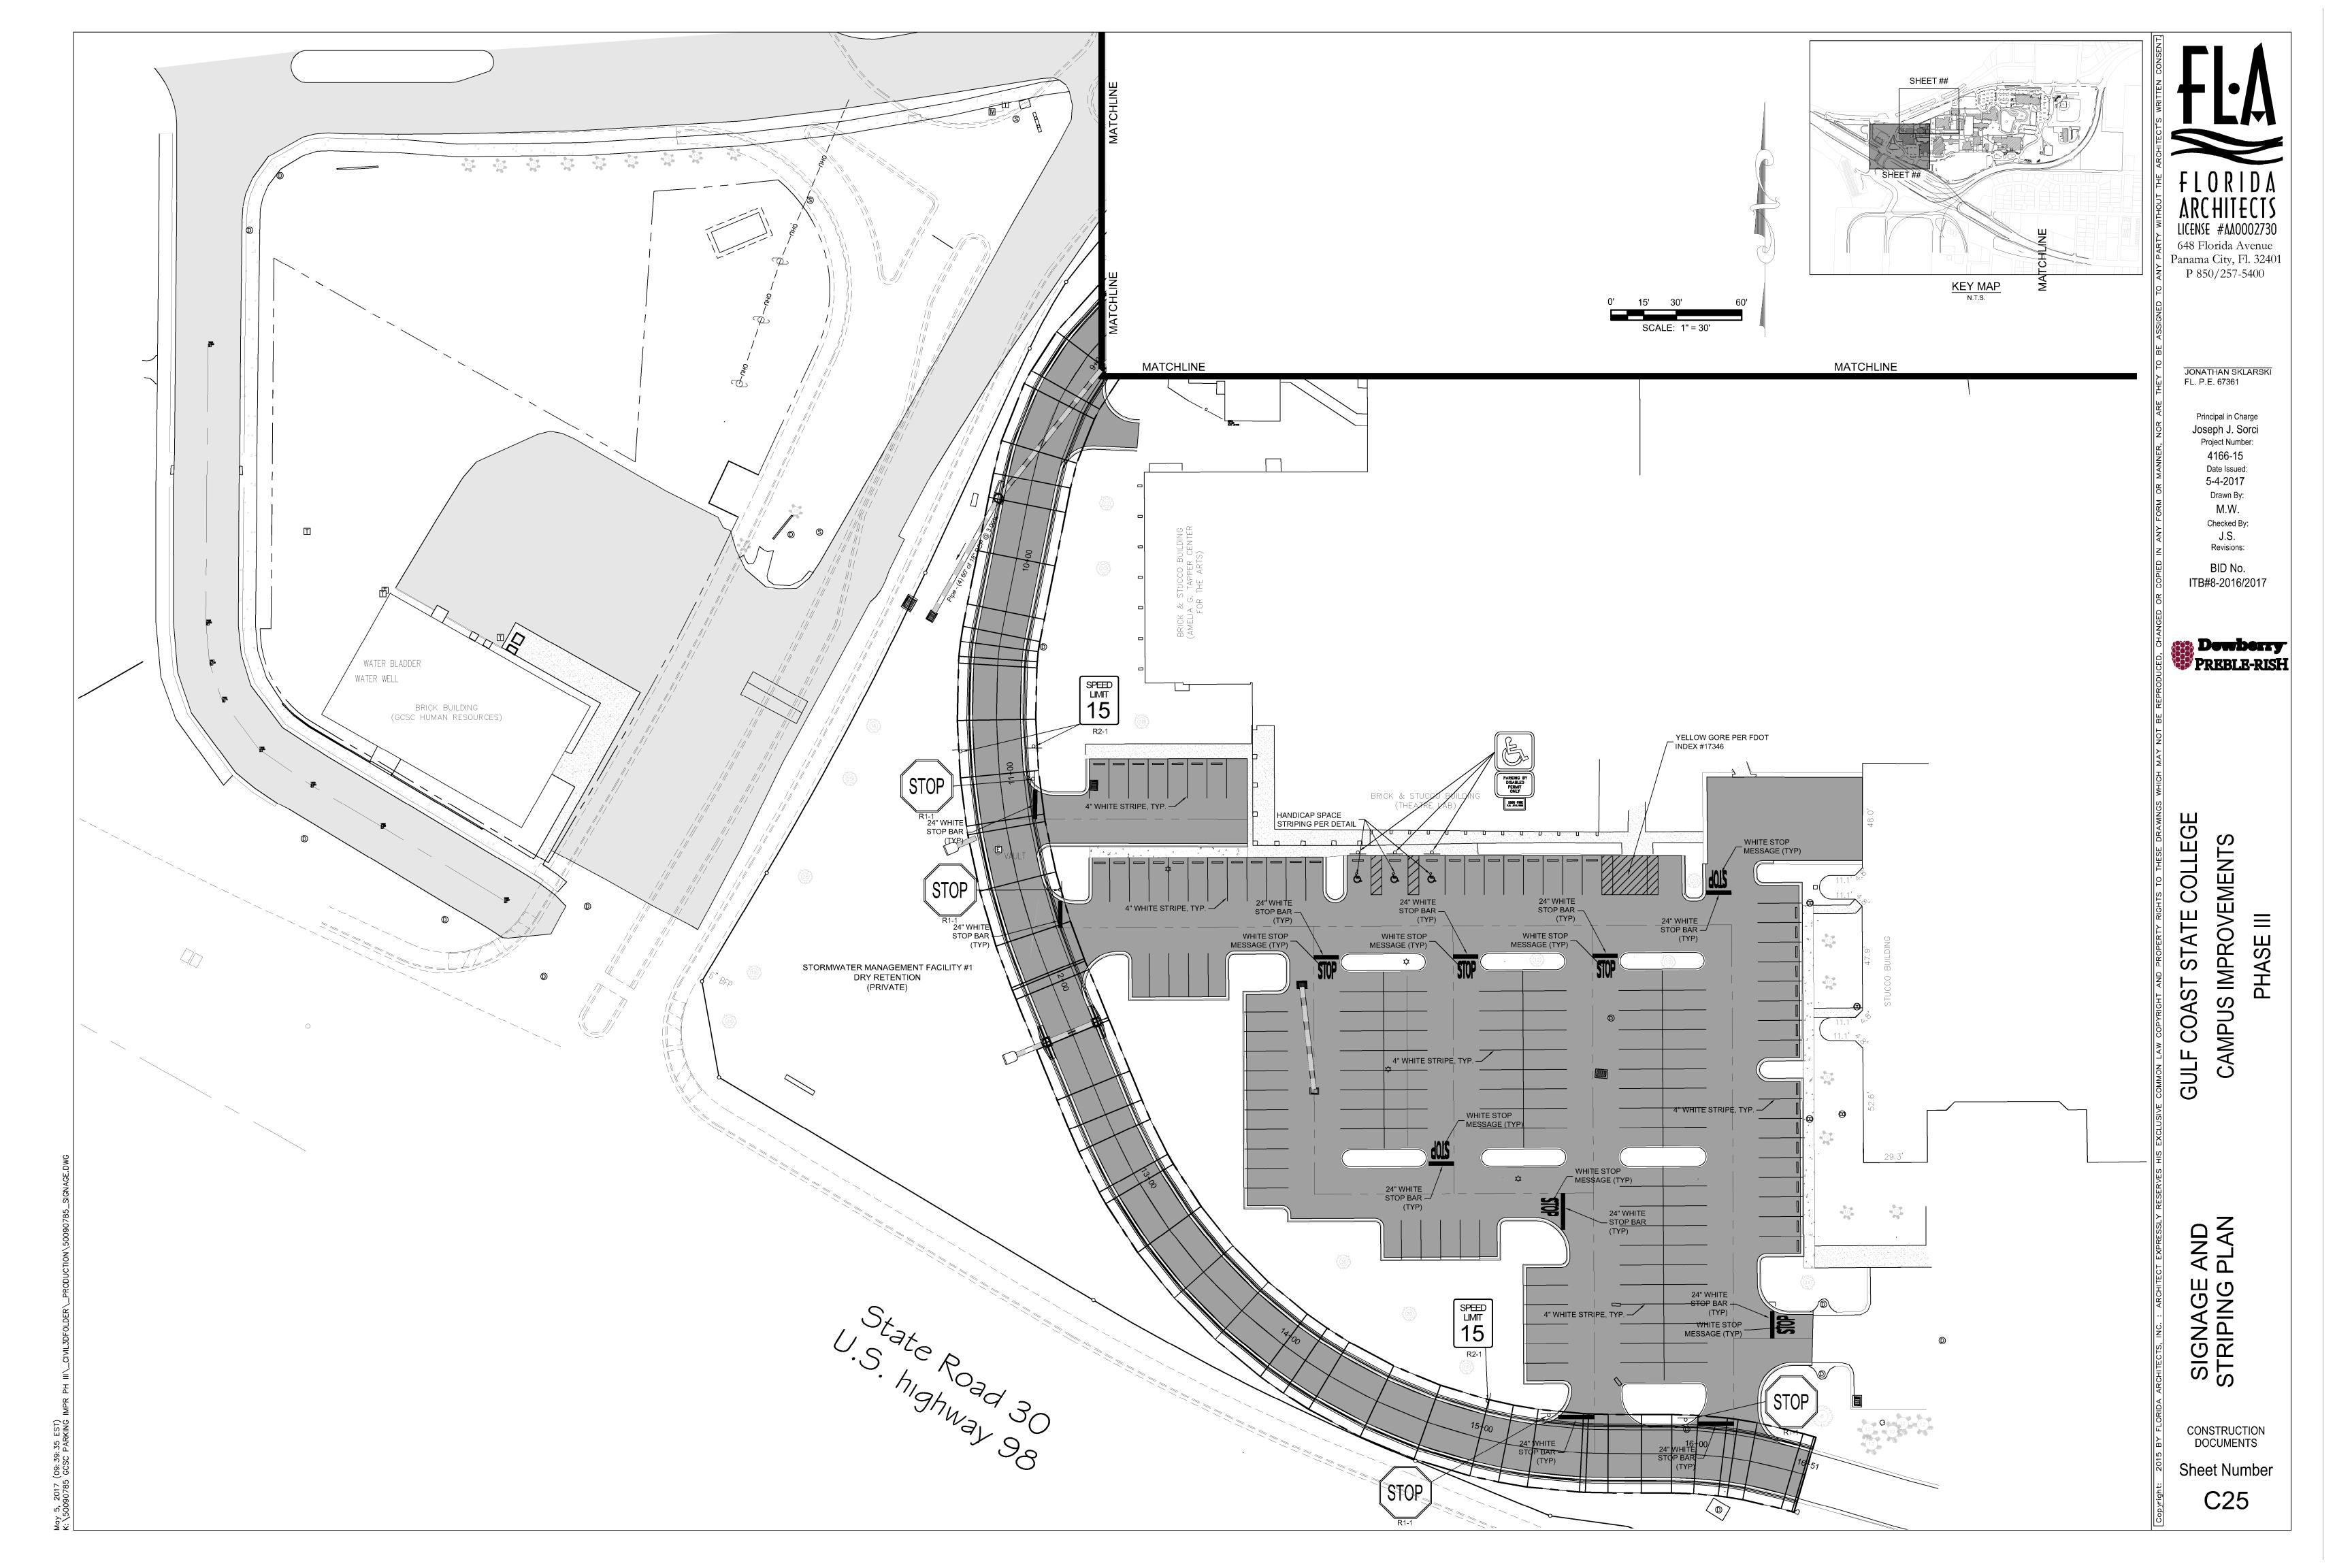

DETAIL SIGNS (TYPICAL)

SCALE: N.T.S.

DETAIL TYPICAL PARKING SPACE STRIPING

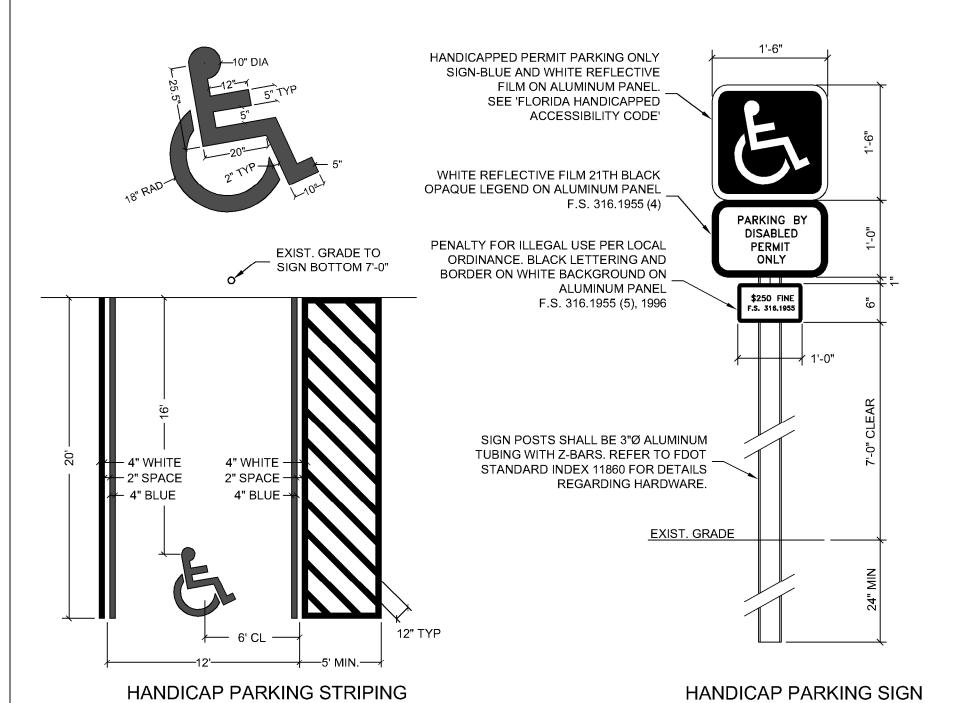


NOTES:

- 1. \*COLOR CONTRAST
  CHARACTERS AND SYMBOLS SHALL CONTRAST WITH THEIR BACKGROUND EITHER LIGHT CHARACTERS ON A DARK
  BACKGROUND OR DARK CHARACTERS ON A LIGHT BACKGROUND.
- 2. EACH PARKING SPACE SHALL BE CONSPICUOUSLY OUTLINED IN BLUE PAINT, AND SHALL BE POSTED AND MAINTAINED WITH A PERMANENT, ABOVE-GRADE SIGN BEARING THE INTERNATIONAL SYMBOL OF ACCESSIBILITY OR THE CAPTION "PARKING BY DISABLED PERMIT ONLY," OR BEARING BOTH SUCH SYMBOL AND CAPTION. SUCH SIGNS SHALL NOT BE OBSCURED BY A VEHICLE PARKED IN THE SPACE. ALL HANDICAPPED PARKING SPACES MUST BE SIGNED AND MARKED IN ACCORDANCE WITH THE STANDARDS ADOPTED BY THE DEPARTMENT OF TRANSPORTATION.

DETAIL HANDICAP PARKING DETAILS

SCALE: N.T.S.

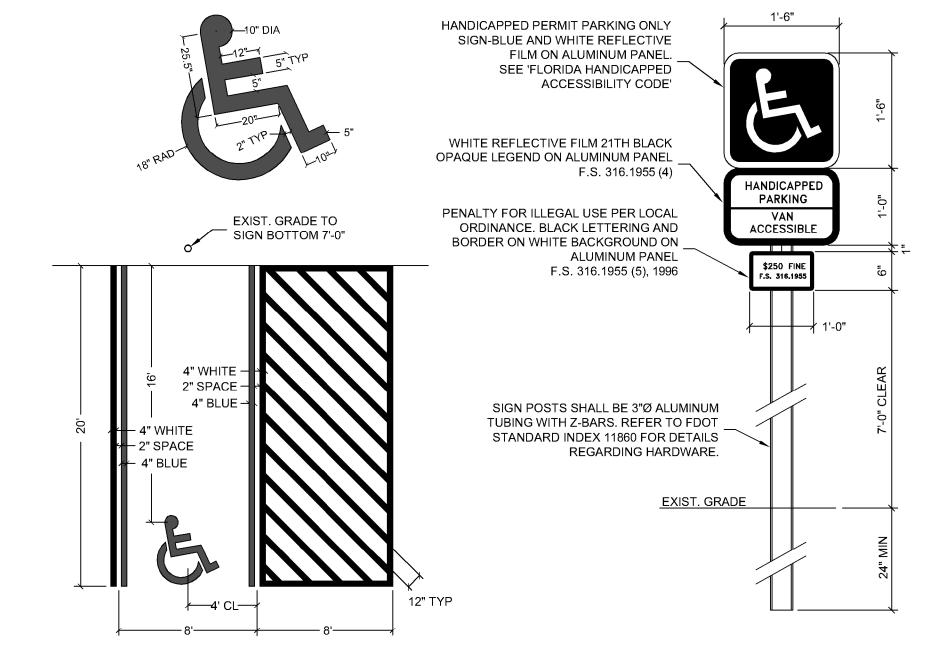

VAN ACCESSIBLE HANDICAP PARKING STRIPING

NOTES:

1. \* COLOR CONTRAST CHARACTERS AND SYMBOLS SHALL CONTRAST WITH THEIR BACKGROUND - EITHER LIGHT CHARACTERS ON A DARK

HANDICAP PARKING SIGN

BACKGROUND OR DARK CHARACTERS ON A LIGHT BACKGROUND.

2. EACH PARKING SPACE SHALL BE CONSPICUOUSLY OUTLINED IN BLUE PAINT, AND SHALL BE POSTED AND MAINTAINED WITH A PERMANENT, ABOVE-GRADE SIGN BEARING THE INTERNATIONAL SYMBOL OF ACCESSIBILITY OR THE CAPTION "PARKING BY DISABLED PERMIT ONLY," OR BEARING BOTH SUCH SYMBOL AND CAPTION. SUCH SIGNS SHALL NOT BE OBSCURED BY A VEHICLE PARKED IN THE SPACE. ALL HANDICAPPED PARKING SPACES MUST BE SIGNED AND MARKED IN ACCORDANCE WITH THE STANDARDS ADOPTED BY THE DEPARTMENT OF TRANSPORTATION.

DETAIL VAN ACCESSIBLE HANDICAP PARKING DETAILS

SCALE: N.T.S.









JONATHAN SKLARSKI FL. P.E. 67361

P 850/257-5400

Principal in Charge
Joseph J. Sorci
Project Number:
4166-15

4166-15
Date Issued:
5-4-2017
Drawn By:
M.W.
Checked By:
J.S.
Revisions:

BID No. ITB#8-2016/2017



COAST STATE COLLEGE
MPUS IMPROVEMENTS

GULF

SNAGE DETAILS


CONSTRUCTION DOCUMENTS

Sheet Number


C26


### TYPICAL SECTION

LANDSCAPE ISLAND

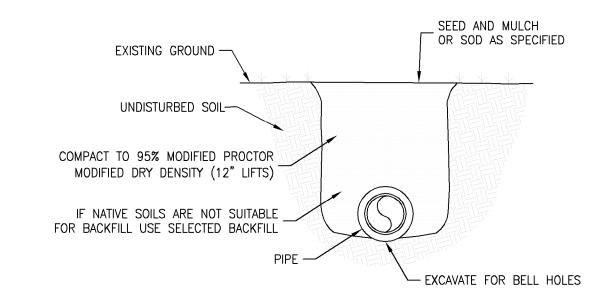



### **DETAIL** STANDARD BEDDING

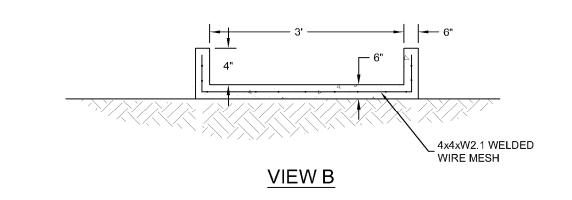


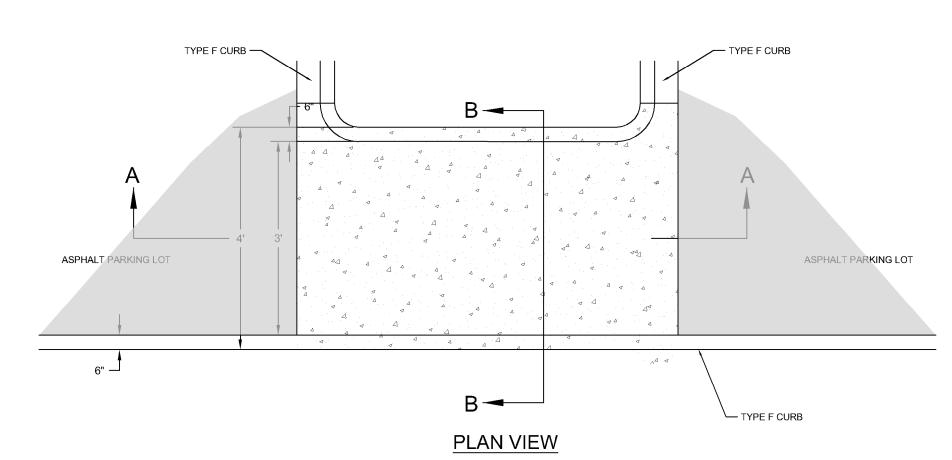

**DETAIL** CONCRETE FLUME

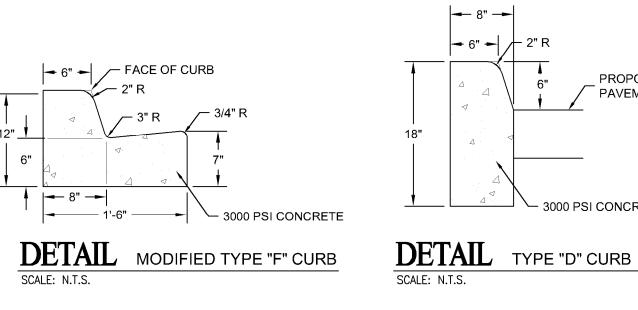


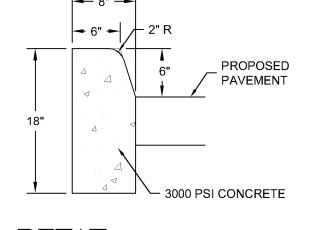

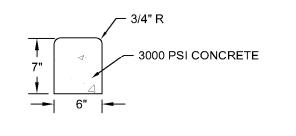




**DETAIL** CONCRETE RIBBON CURB

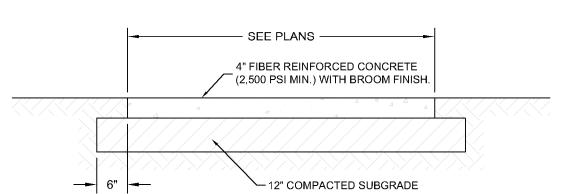


### SIDEWALK CROSS SECTION

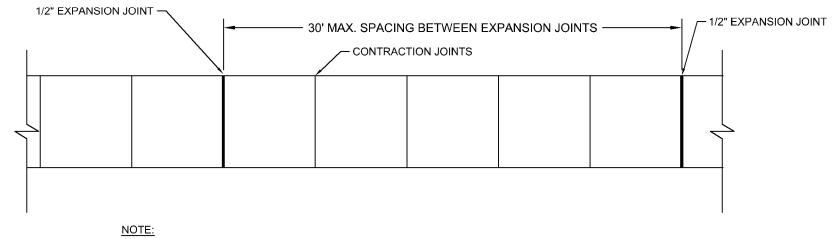


- ALL SIDEWALKS SHALL BE 4" THICK WITH BROOM FINISH.
   FOR WALKS 8' AND NARROWER, SPACE TRANSVERSE CONTRACTION JOINTS AT INTERVAL EQUAL TO
- WIDTH OF WALK OR AS NOTED.
- 3. CONTRACTION JOINTS TO BE 1" DEEP SCORED. SAW-CUT, OR FORMED WITH INSERT AT CONTRACTORS OPTION UNLESS NOTED OTHERWISE. SCORED JOINTS TO USE AN APPROVED TOOL. INSERTS TO BE GREENSTREAK ZIPCAP #855 OR EQUAL. SCORED JOINTS TO BE EDGED WITH 1/8" RADIUS.
- 4. EXPANSION JOINT REQUIRED WHERE SHOWN. EXPANSION JOINT TO CONSIST OF 1/2" FIBER BOARD AND GREENSTREAK CAP SEAL #624 OR EQUAL.
- 5. ALL SIDEWALKS SHALL HAVE A MINIMUM 2% CROSS SLOPE.


#### DETAIL SIDEWALK SCALE: N.T.S.

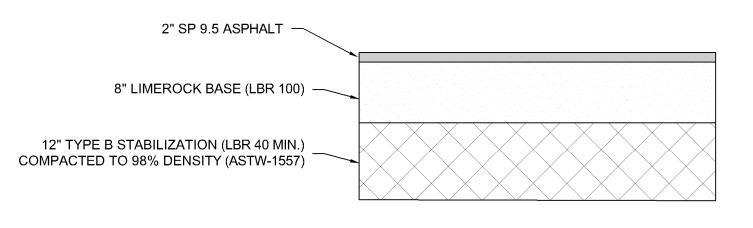

TYPICAL SECTION FULL DEPTH ASPHALT PAVING

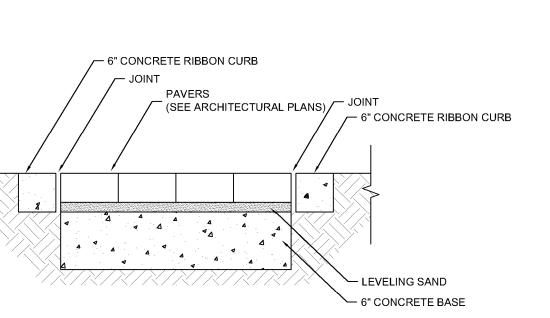



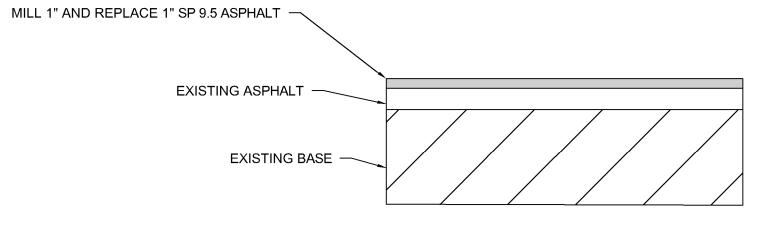

3/4" DIA. HOLE (2 REQ'D) -

(2)-# 4 BARS (5'-6" LONG)-

TYPICAL SECTION ASPHALT OVERLAY PAVING

LICENSE #AAOOO2730 648 Florida Avenue Panama City, Fl. 32401 P 850/257-5400

JONATHAN SKLARSKI FL. P.E. 67361

Principal in Charge Joseph J. Sorci Project Number: 4166-15 Date Issued: 5-4-2017 Drawn By: M.W. Checked By: J.S. Revisions:

BID No. ITB#8-2016/2017



COLLEGE CAMPUS IMPROVEMENT STATE COAST

GULF

3,000 P.S.I. CONCRETE AFTER 28 DAYS.

2"(TYP.) -

→ 6" CONCRETE RIBBON CURB

- LEVELING SAND

─ 4" CONCRETE BASE

4"---2"--

(2) #5 BARS, 18" LONG ----

**DETAIL** TYPICAL PRECAST CONCRETE WHEEL STOP


PAVER SIDEWALK


(SEE ARCHITECTURAL PLANS)/ JOINT

6" CONCRETE RIBBON CURB

MISCELLANEOUS DETAILS

CONSTRUCTION DOCUMENTS

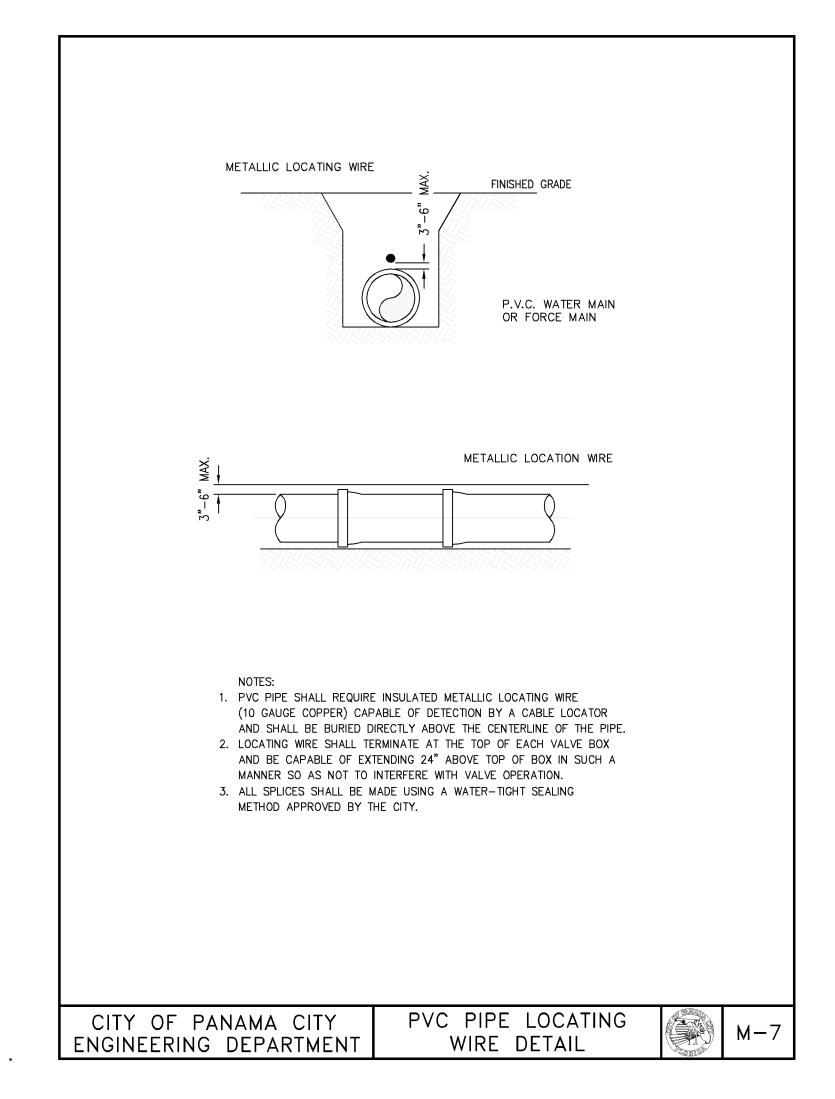

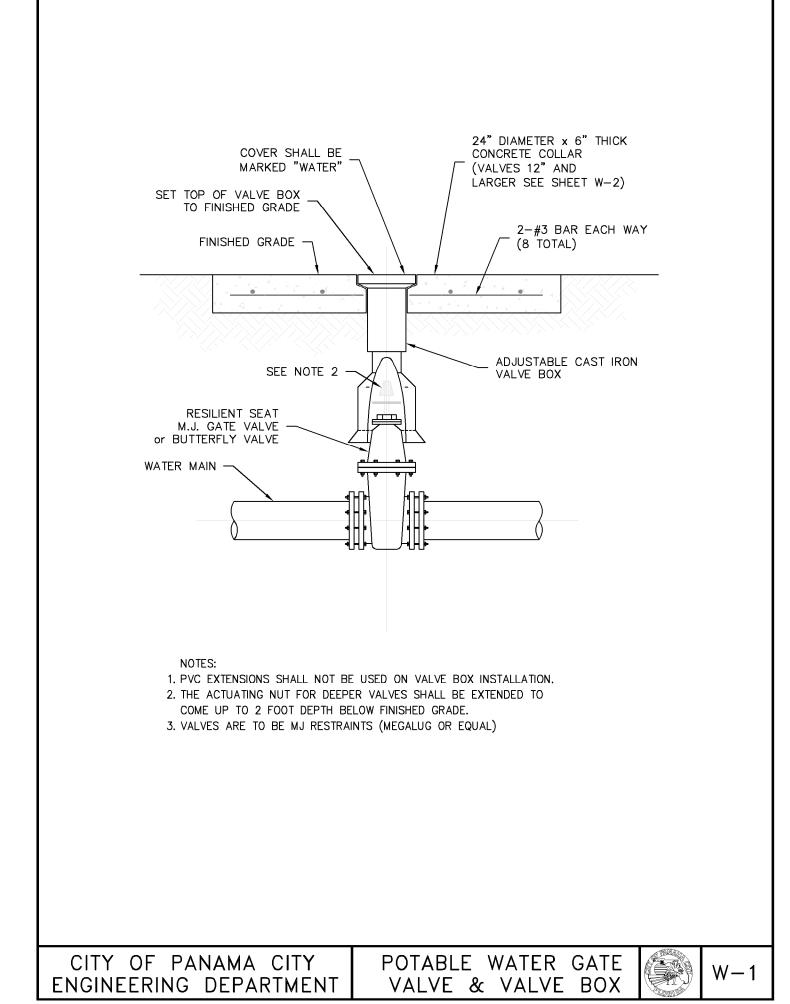

F L O R I D A
ARCHITECTS
LICENSE #AA0002730
648 Florida Avenue
Papama City Fl 32401

Panama City, Fl. 32401 P 850/257-5400

> JONATHAN SKLARSKI FL. P.E. 67361

Principal in Charge Joseph J. Sorci Project Number:

4166-15
Date Issued:
5-4-2017
Drawn By:
M.W.
Checked By:
J.S.

BID No. ITB#8-2016/2017

Revisions:



PREBLE-


GULF COAST STATE COLLEGE CAMPUS IMPROVEMENTS


> MISCELLANEOUS DETAILS


CONSTRUCTION DOCUMENTS


Sheet Number


D2

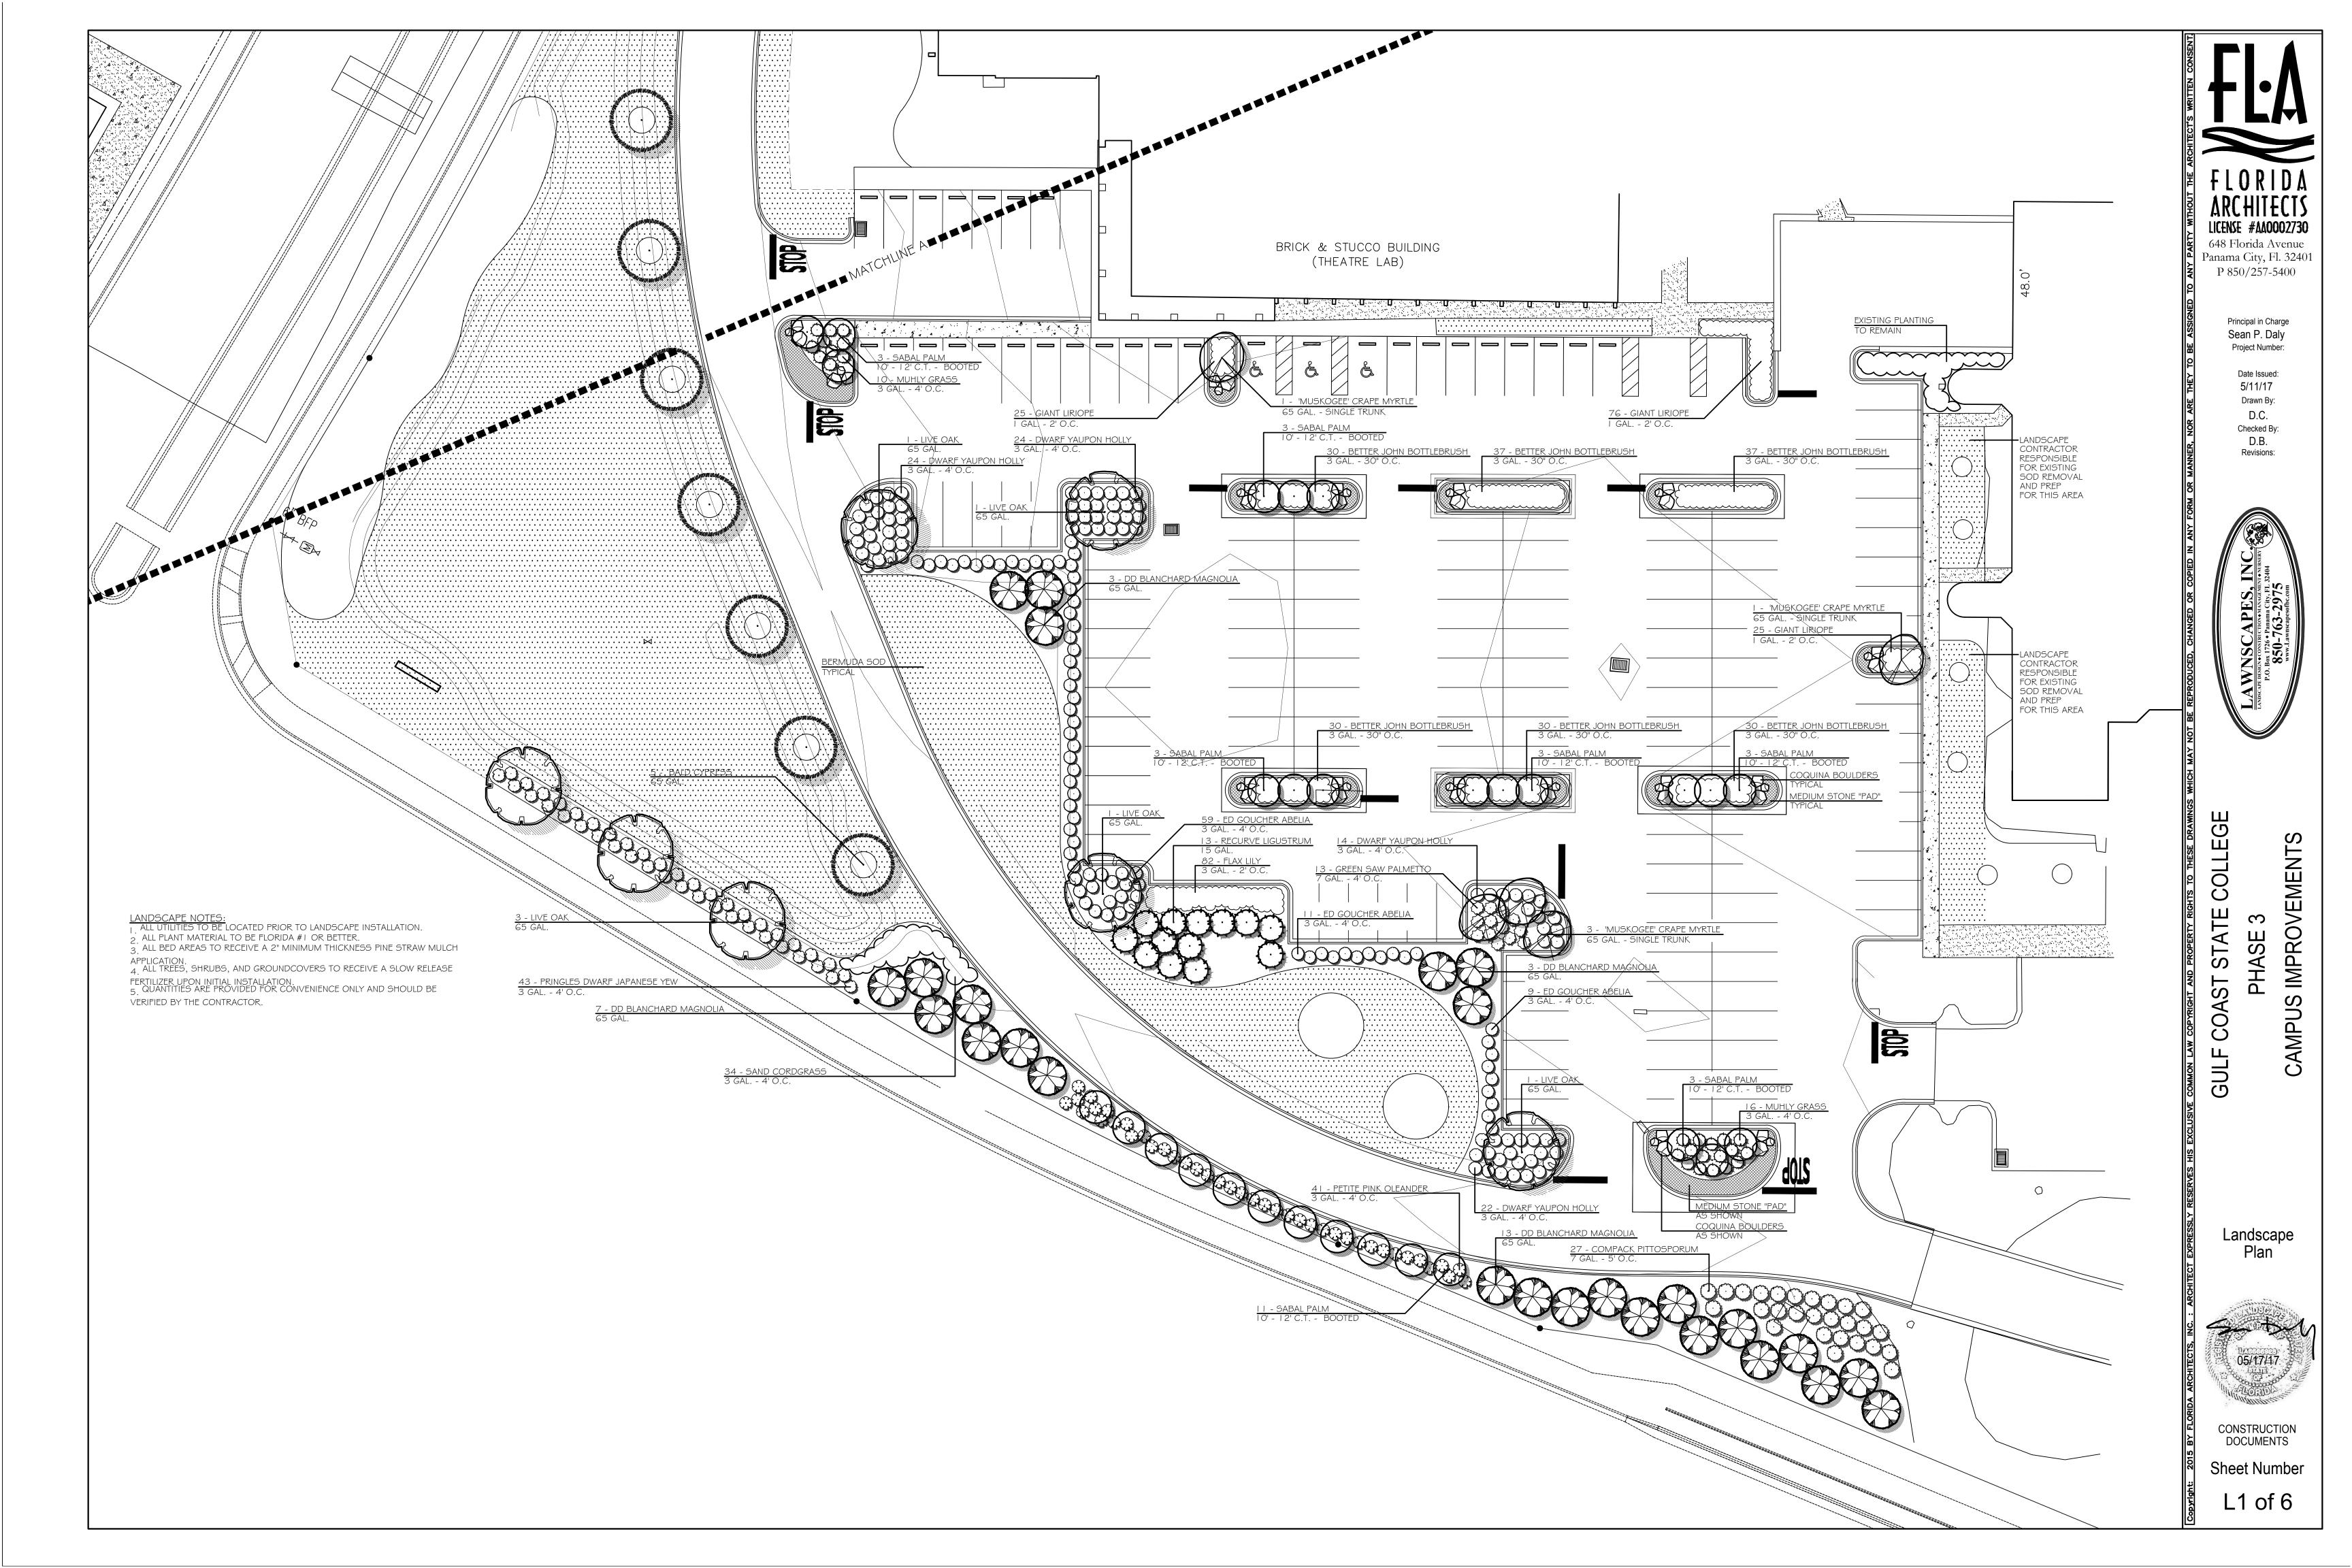


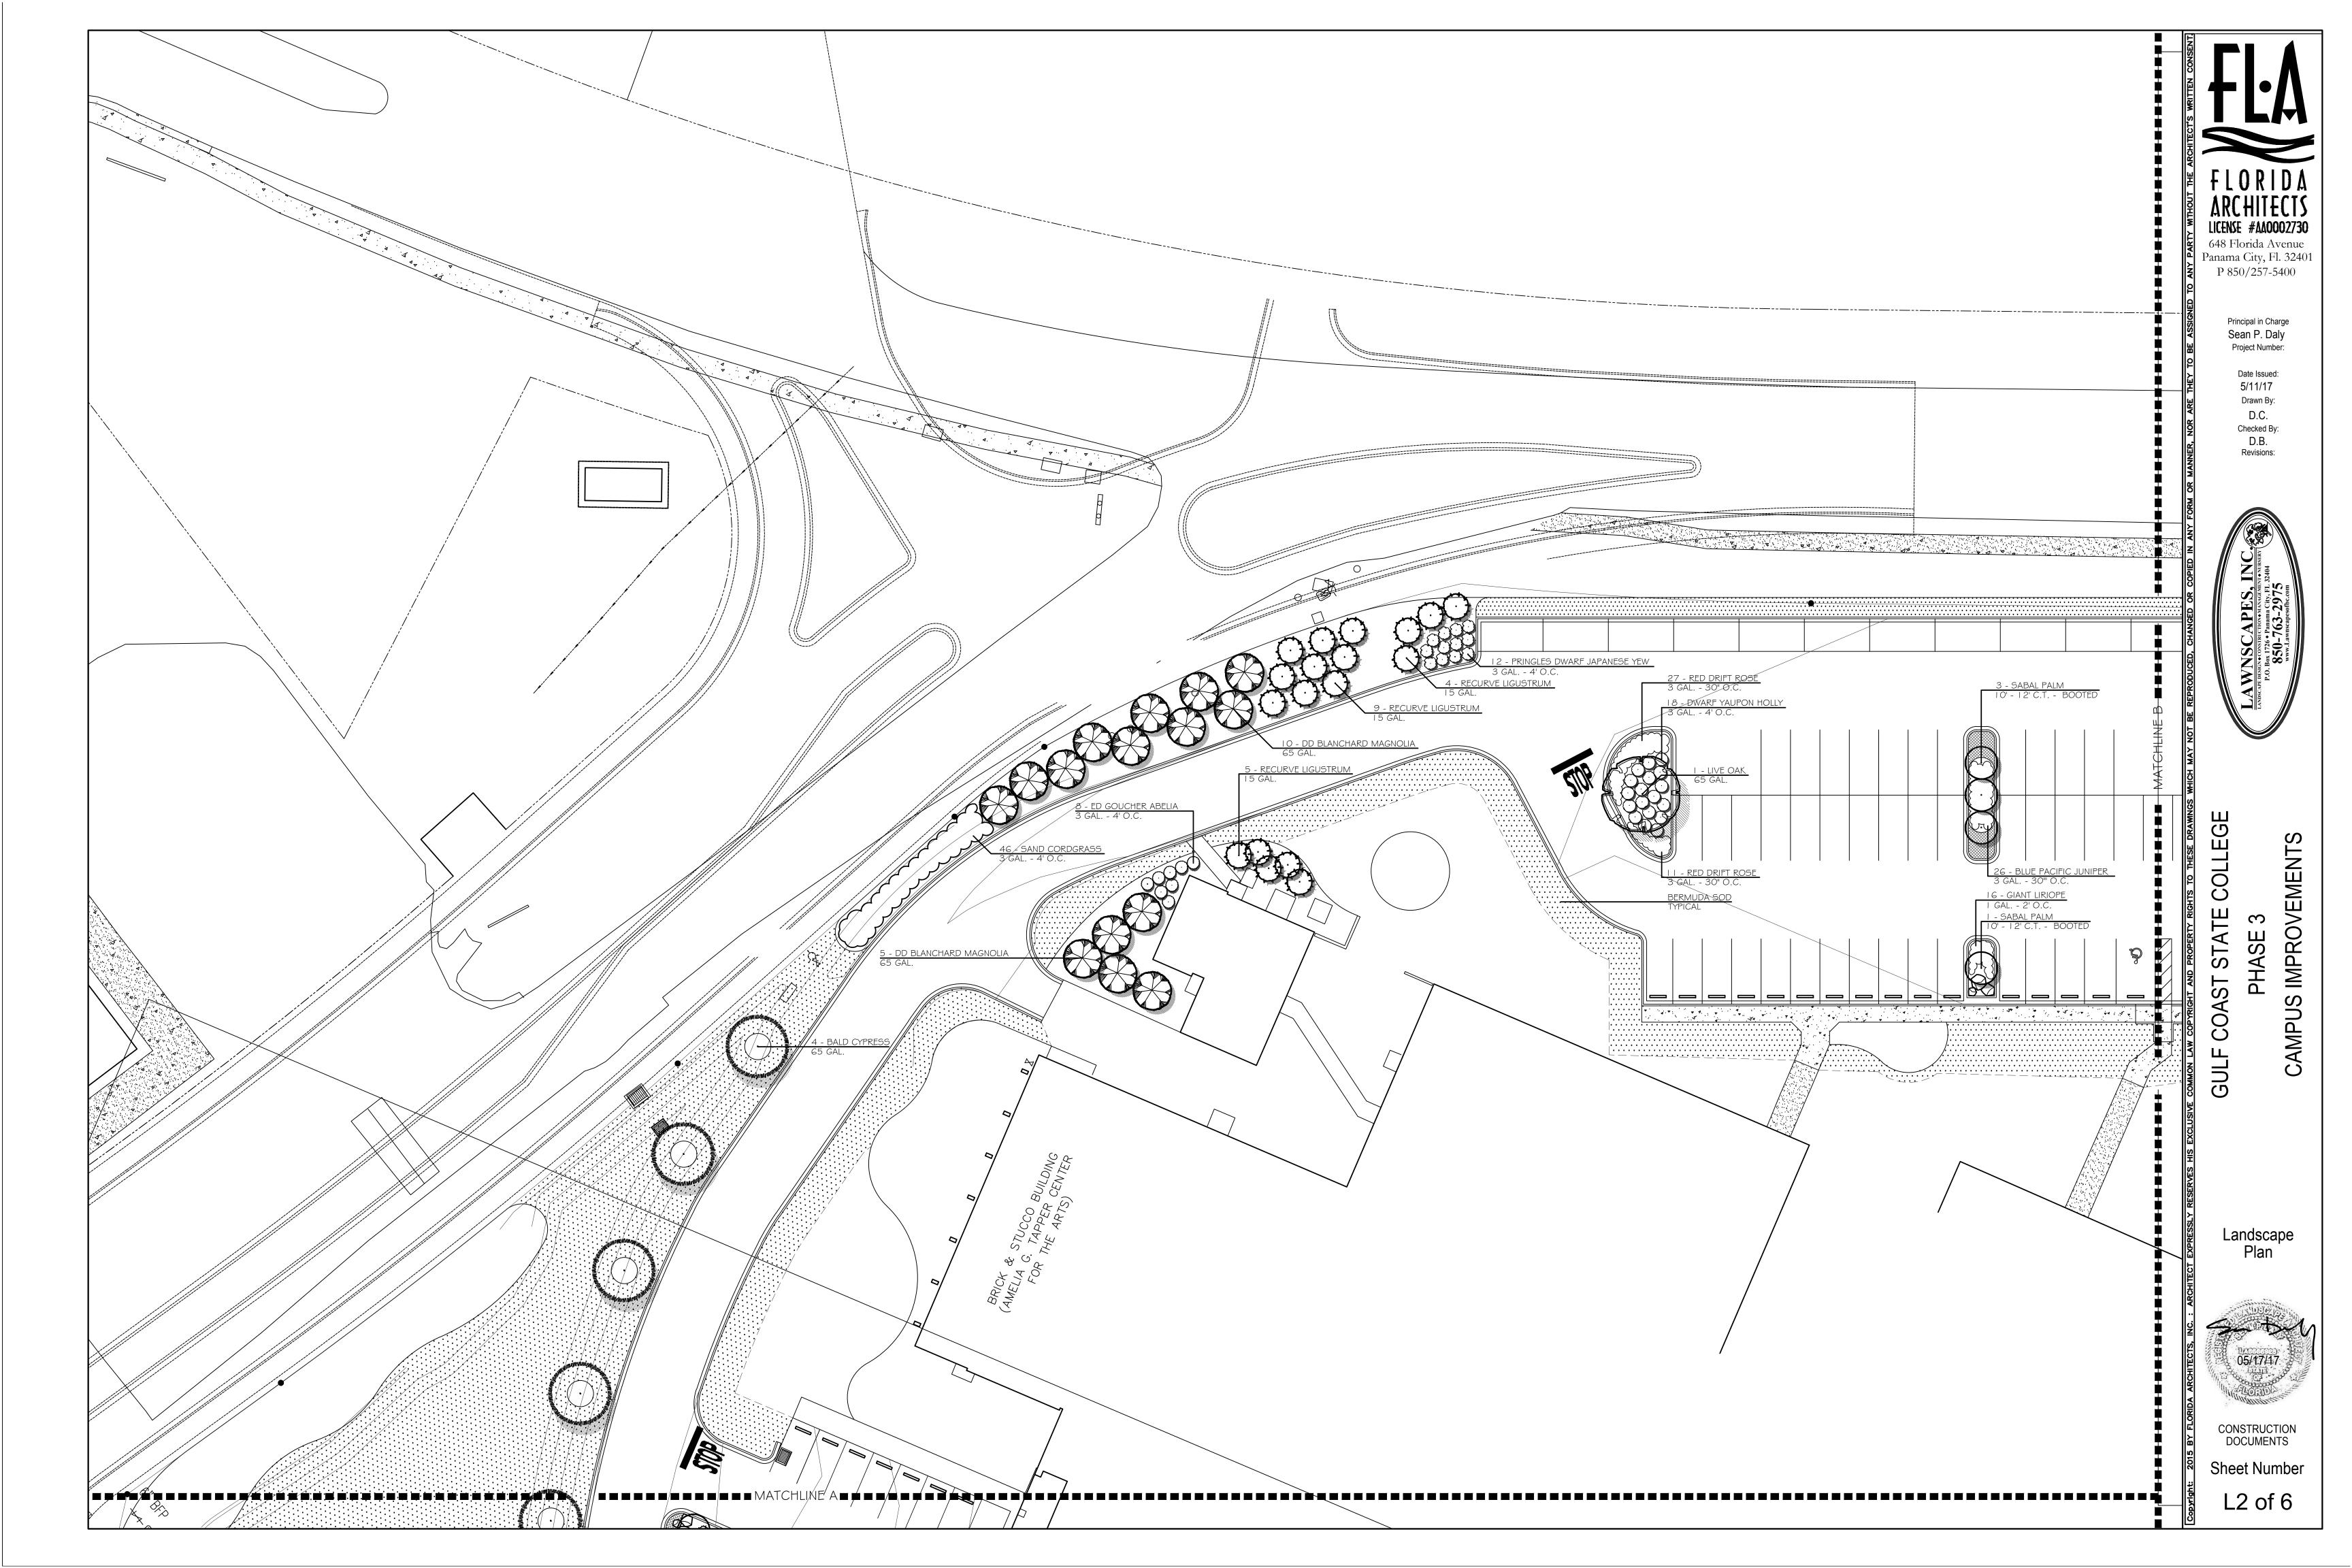

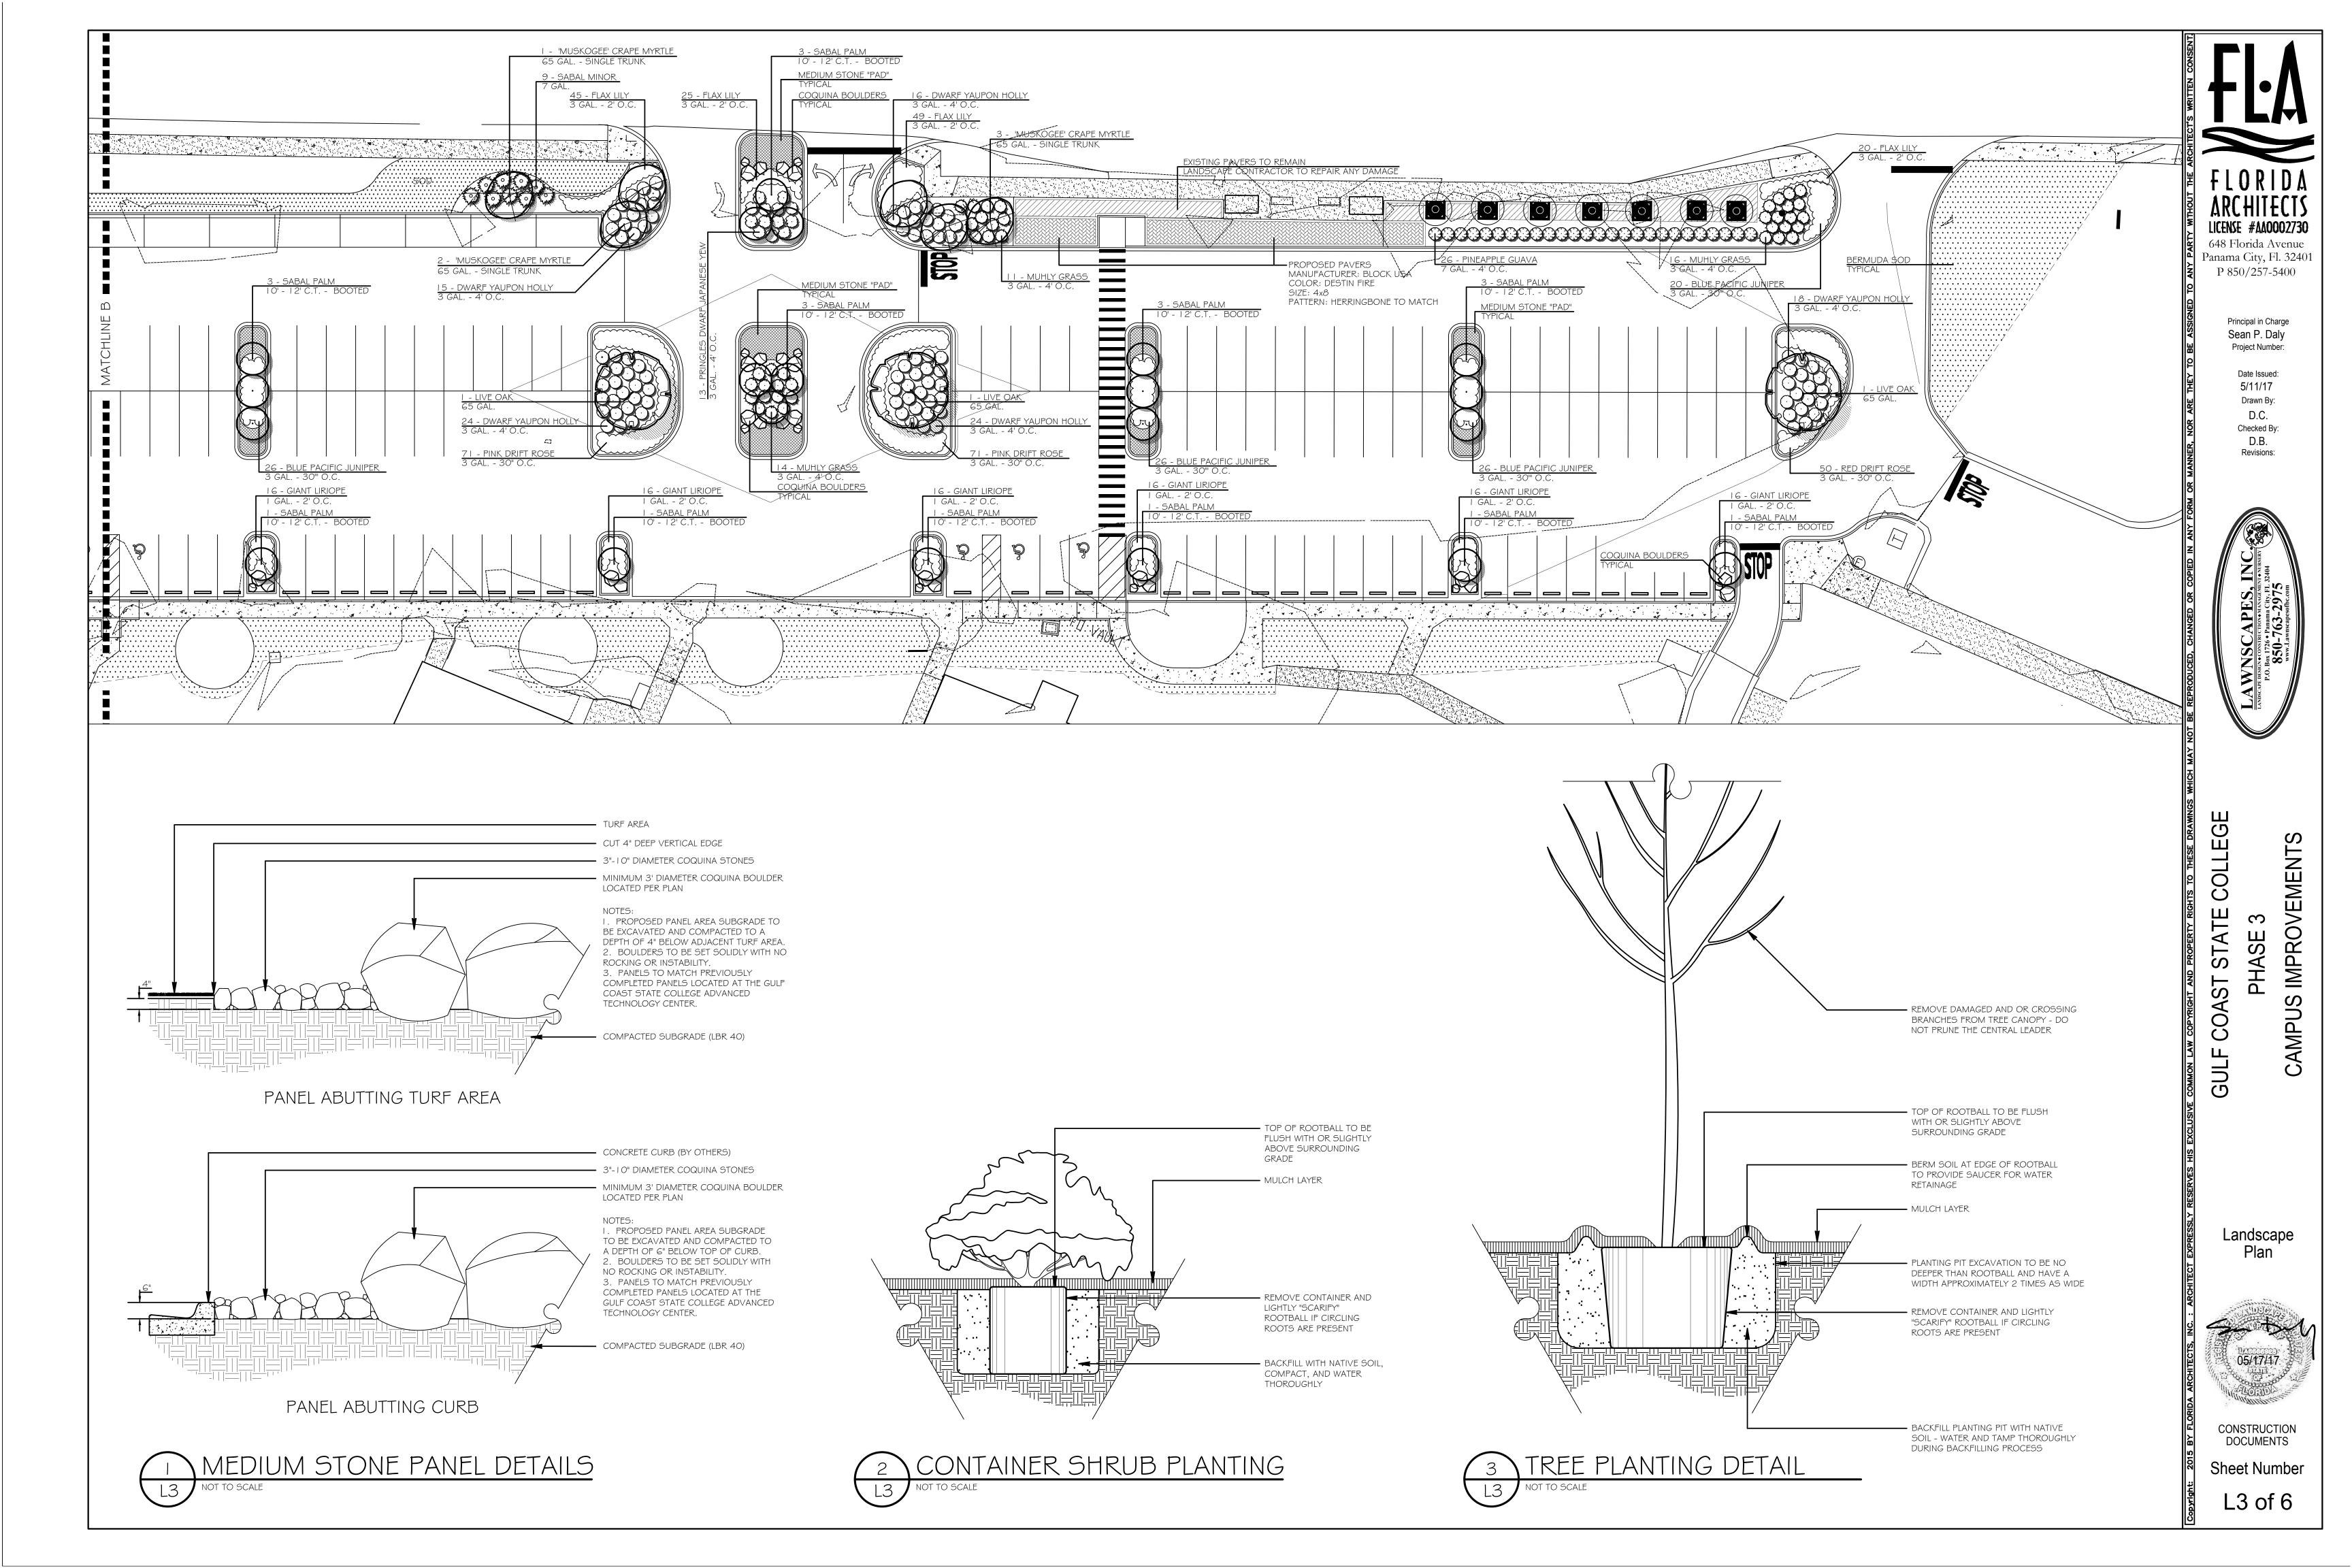


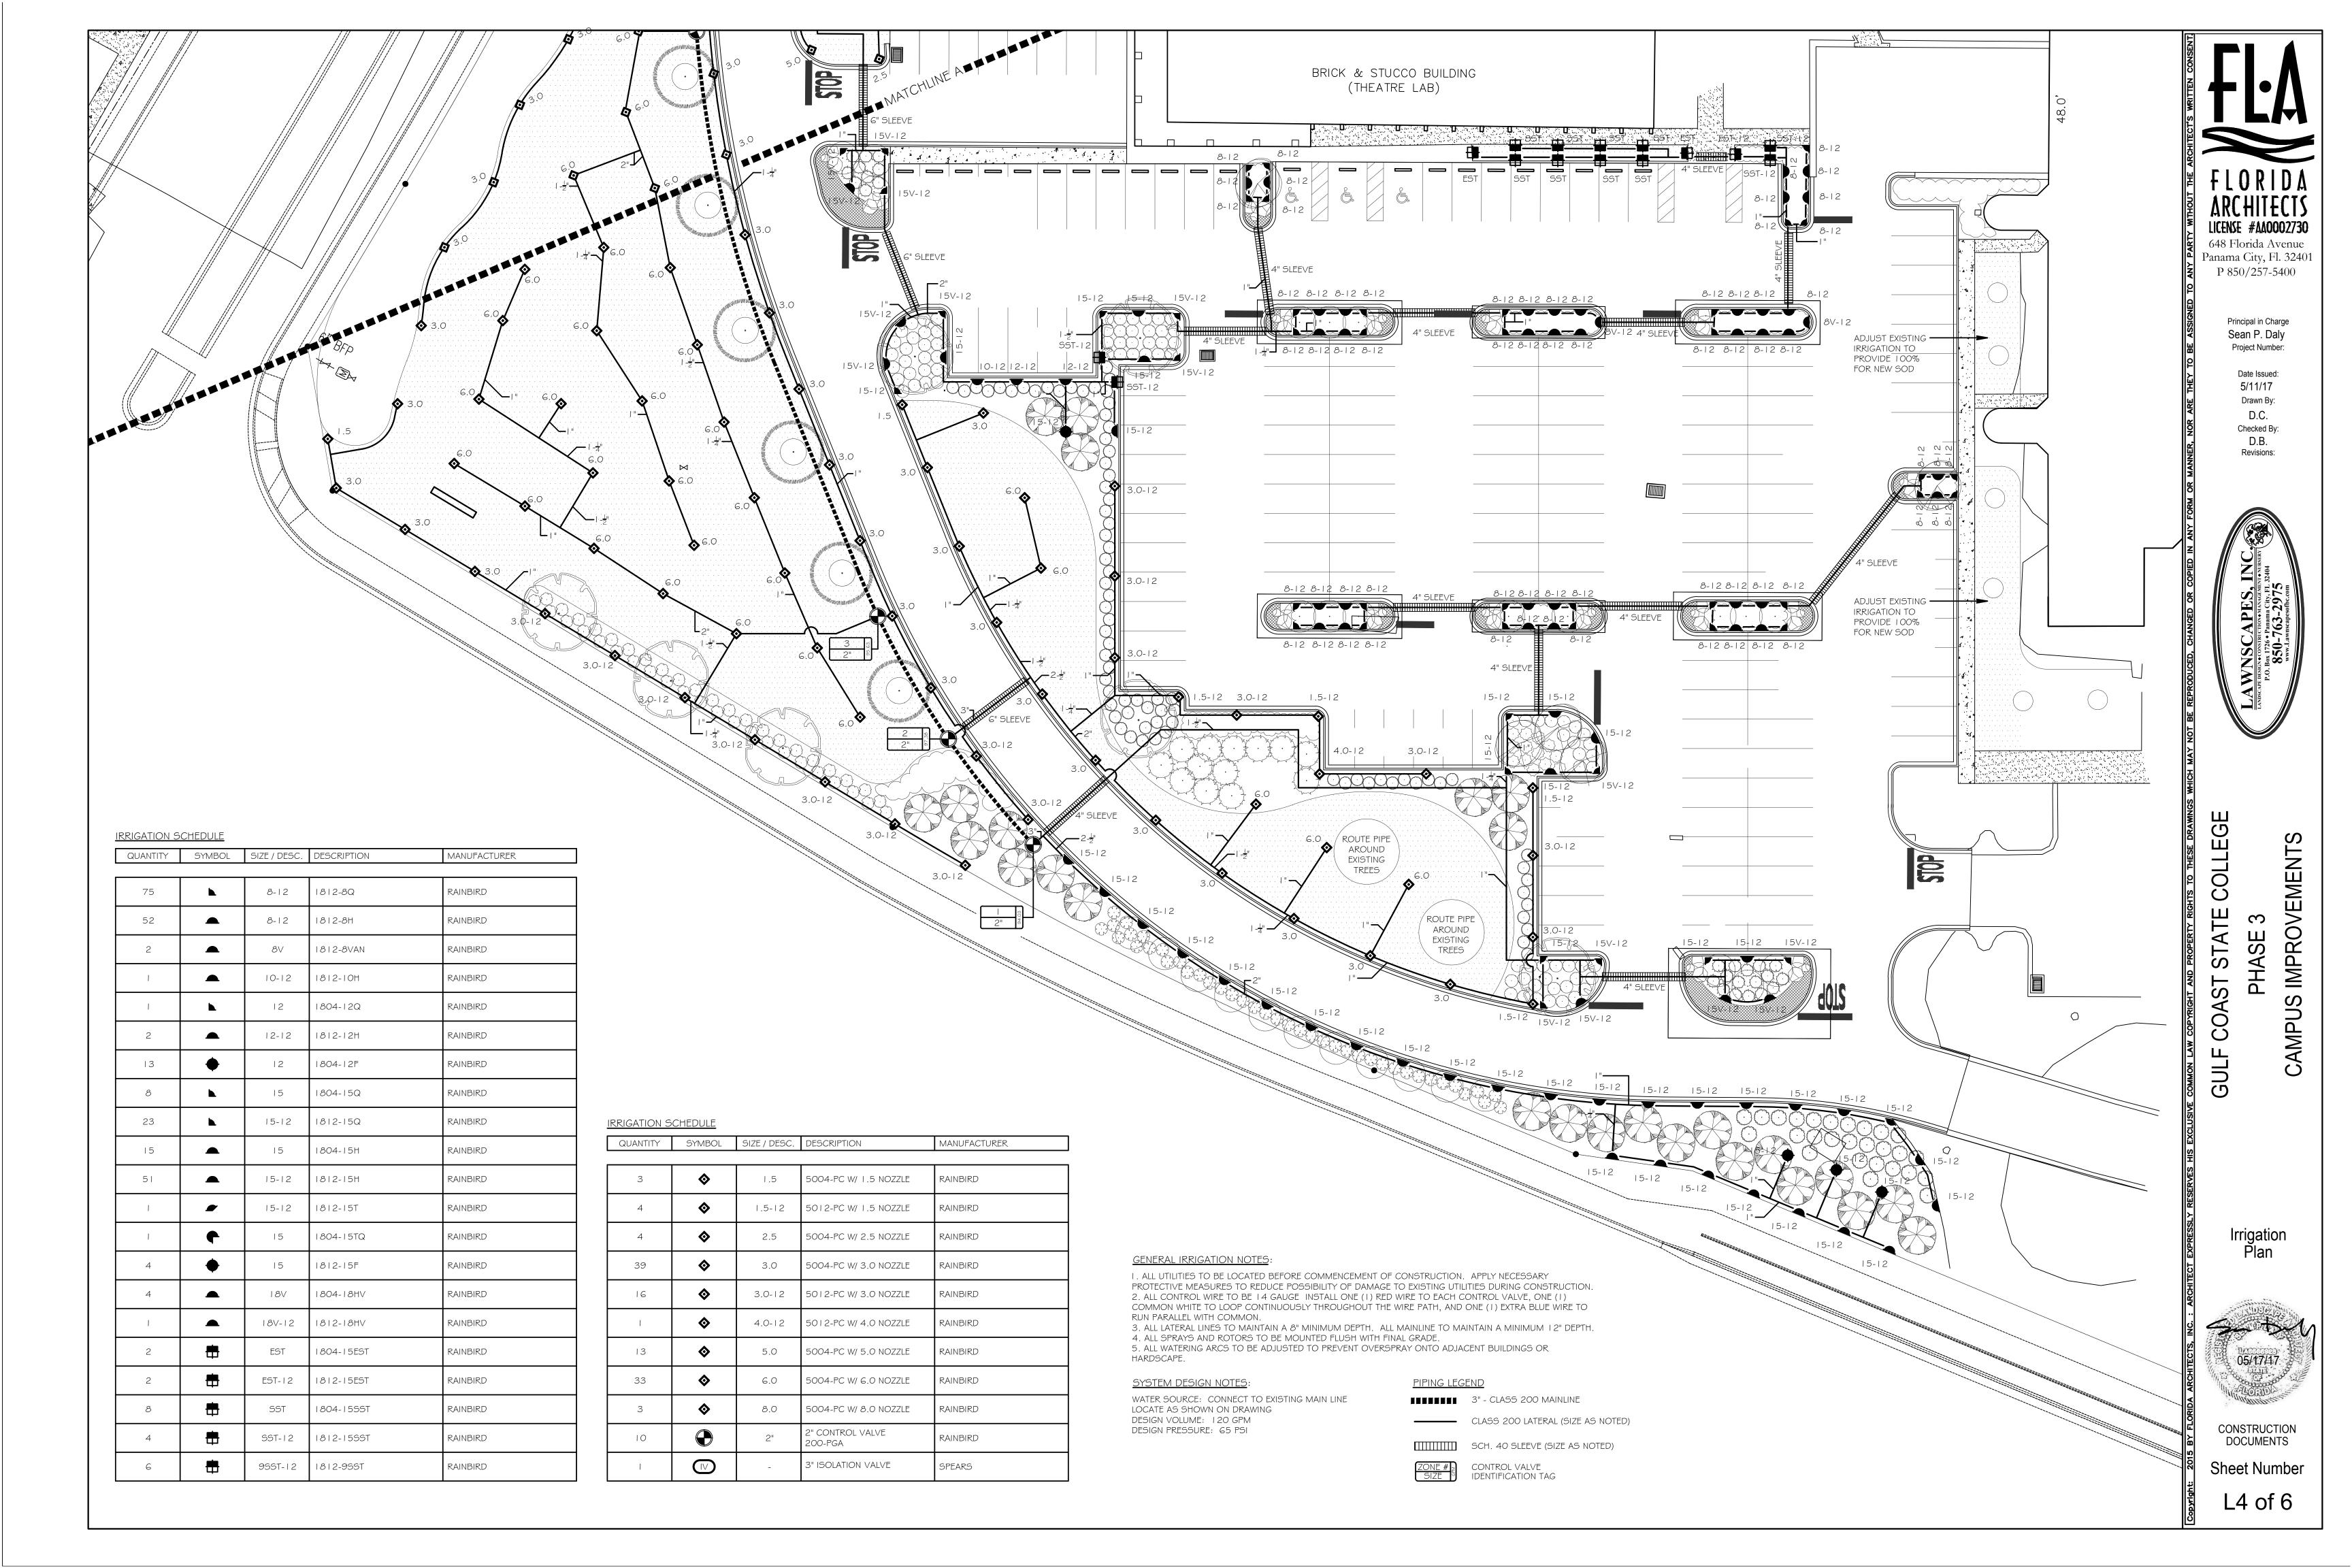

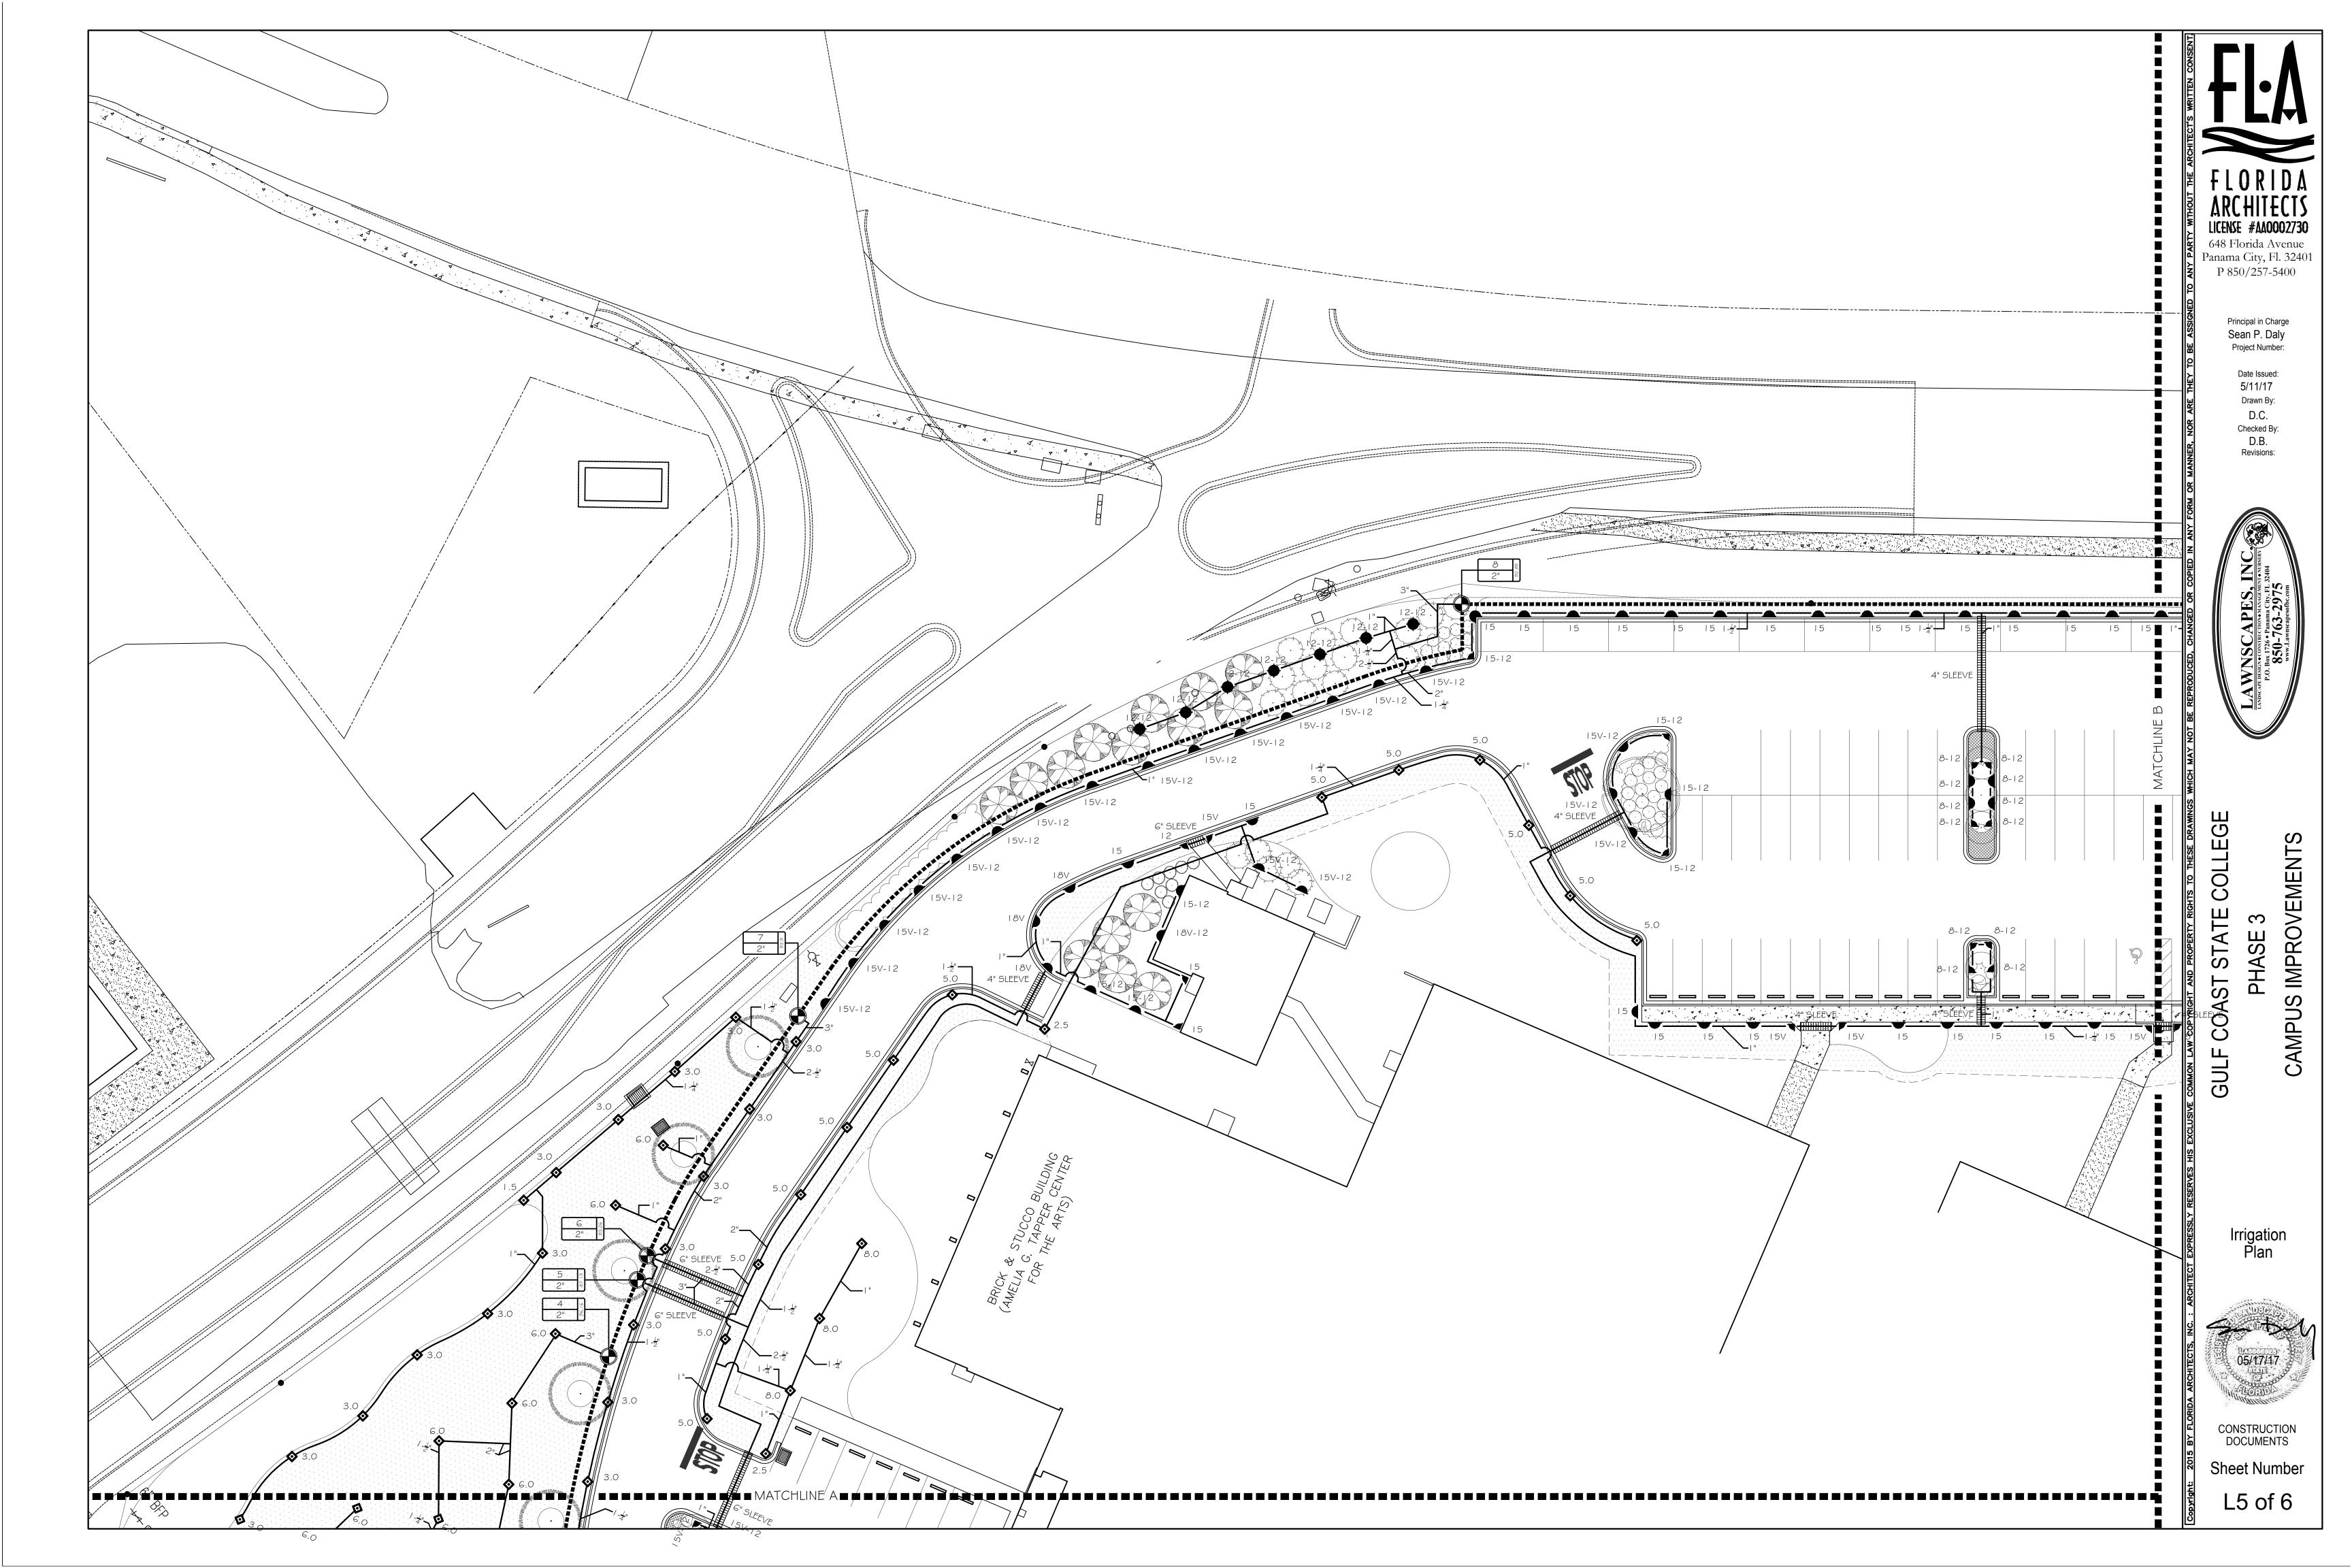

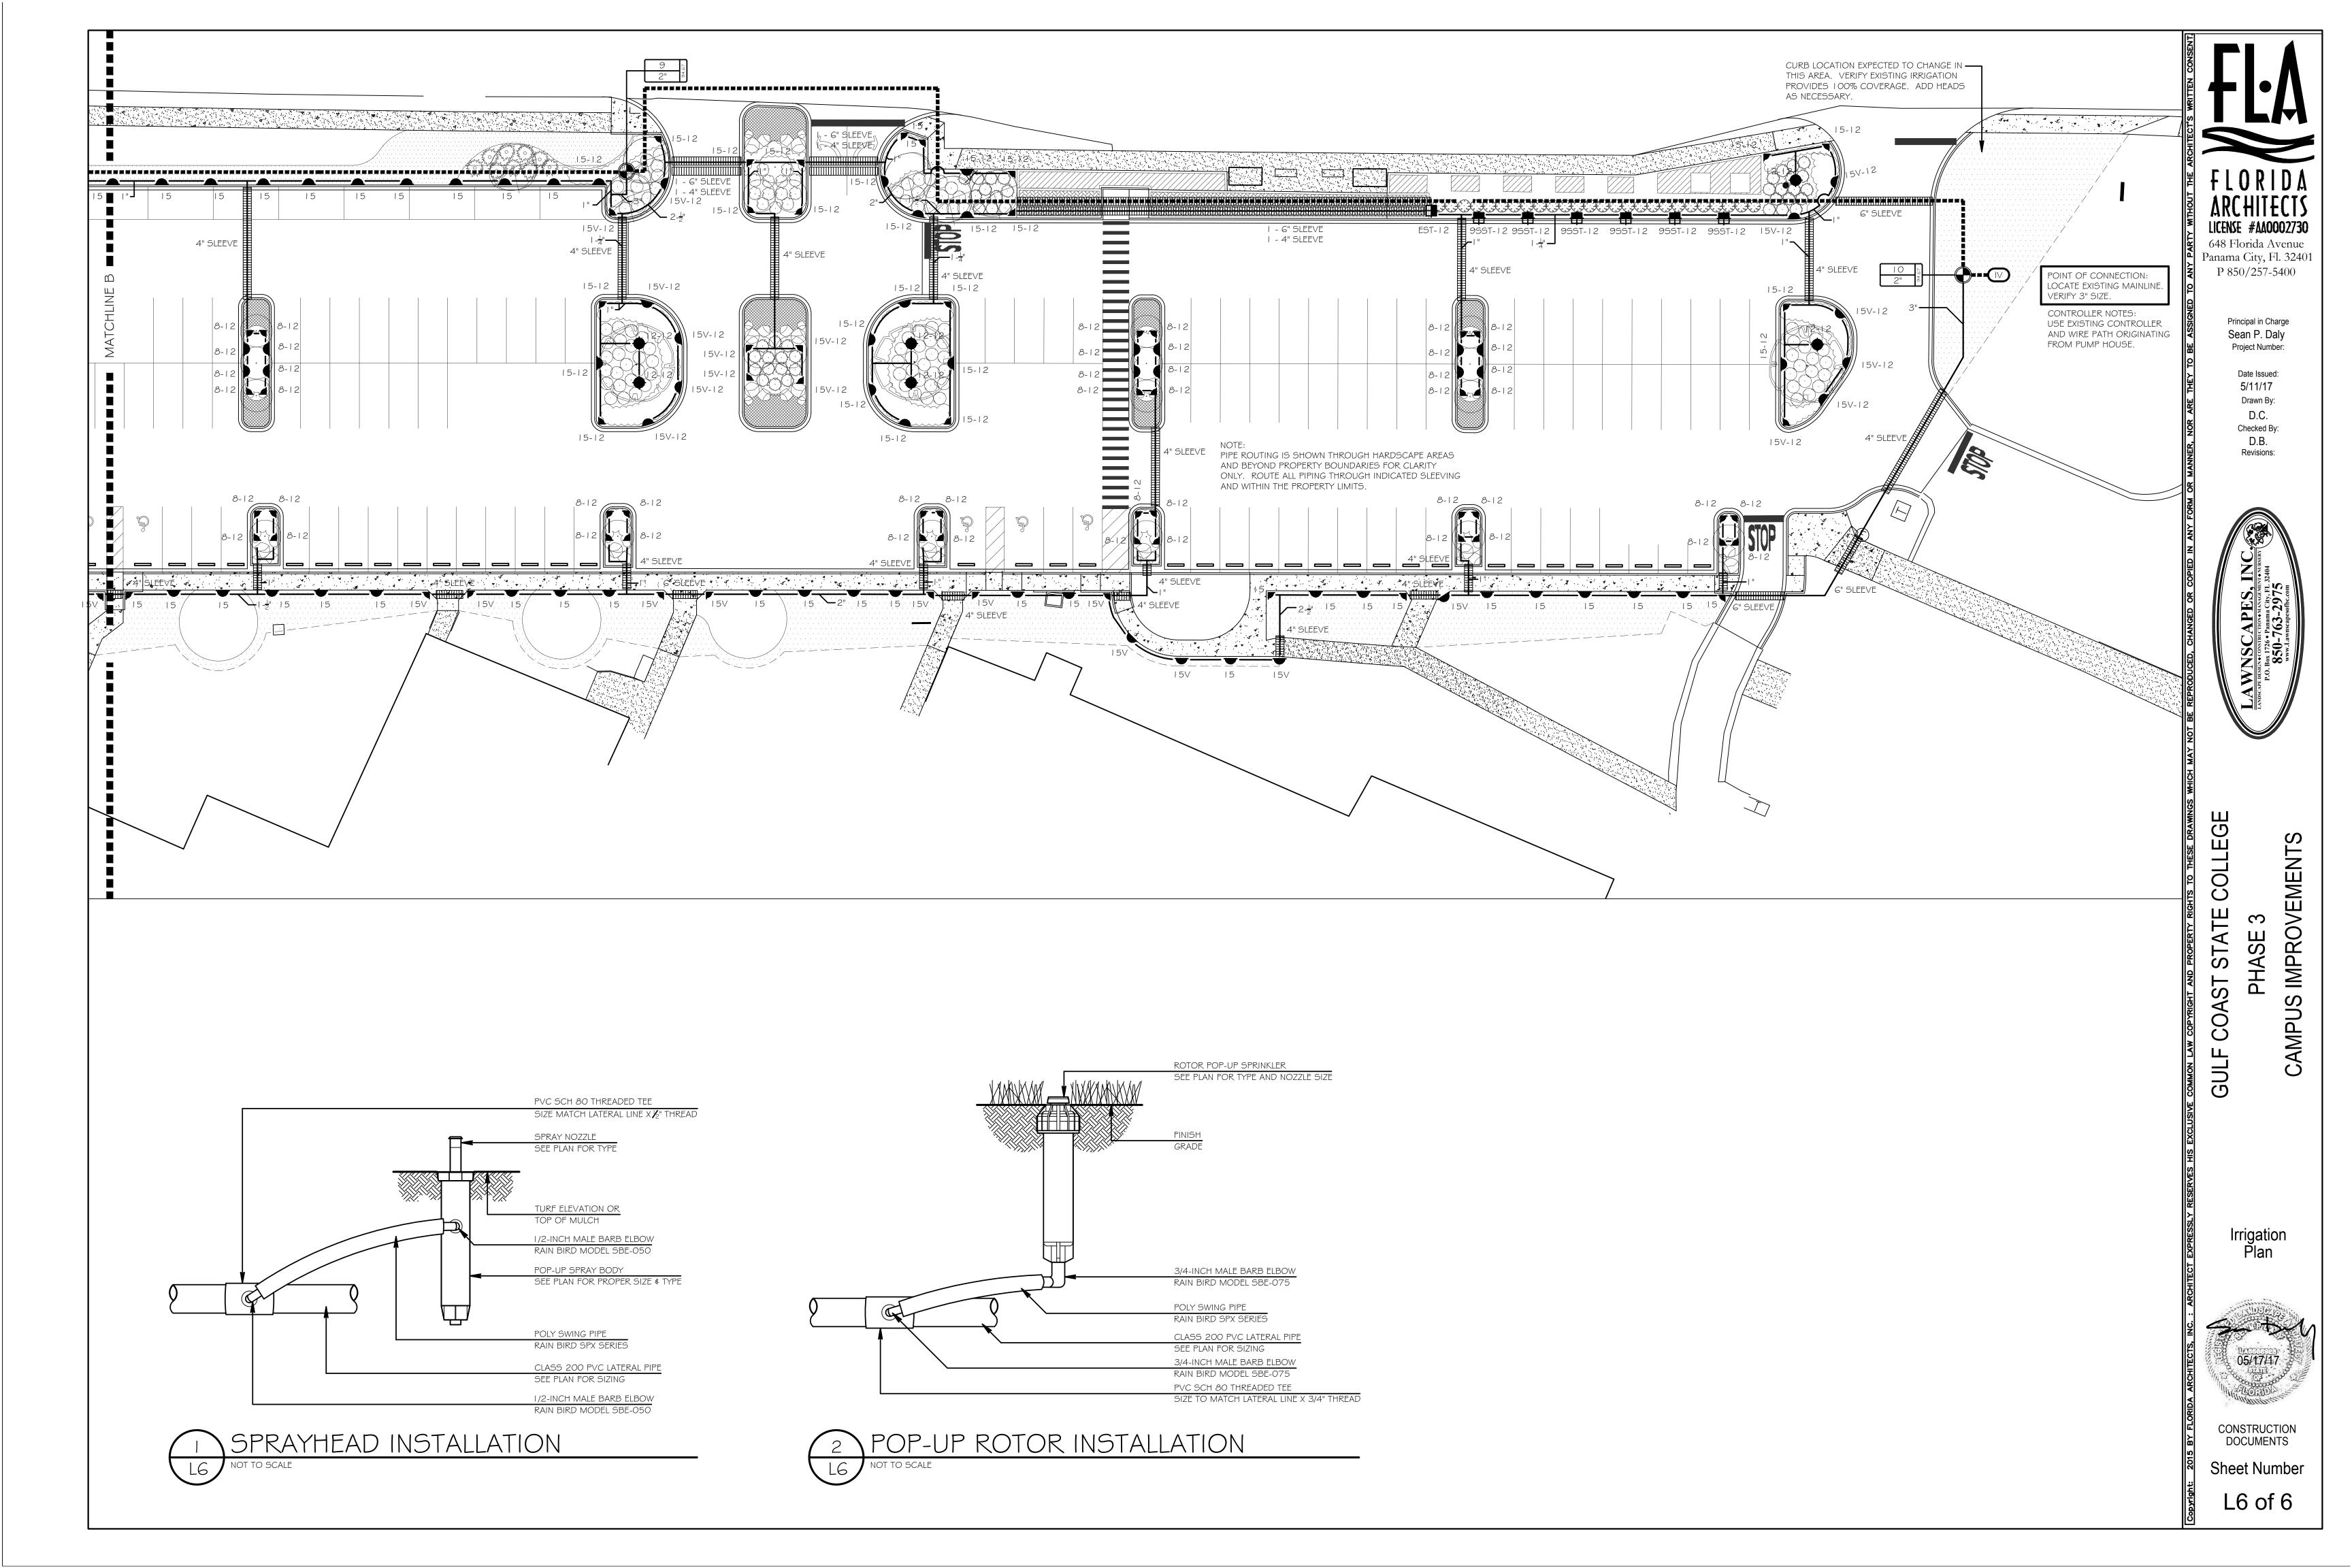

#### ELECTRICAL LEGEND <u>LIGHTING</u> NEW SINGLE LED FIXTURE (1 LED FIXTURE) WITH 30' POLE AND ROUND BASE; INSTALL A TWIST LOCK LIGHTING CONTROLLER IN A PHOTOCELL RECEPTACLE AT THE TOP OF THE FIXTURE. REFER TO REQUIREMENTS IN THE LIGHTING FIXTURE SCHEDULE. INSTALL CONTROLLER PER THE MANUFACTURERS RECOMMENDATIONS. NEW DOUBLE LED FIXTURE (TWO LED FIXTURES) WITH 30' POLE AND ROUND BASE; INSTALL A TWIST LOCK LIGHTING CONTROLLER IN A PHOTOCELL RECEPTACLE AT THE TOP OF EACH FIXTURE. REFER TO REQUIREMENTS IN THE LIGHTING FIXTURE SCHEDULE. INSTALL CONTROLLER PER THE MANUFACTURERS RECOMMENDATIONS. BRANCH CIRCUITING ----- RUN CONCEALED UNDER FLOOR OR IN GRADE RUN CONCEALED ABOVE CEILING HOMERUN TO PANEL. LETTERS AND NUMERALS INDICATED PANEL AND CIRCUIT NUMBER. PANELS AND POWER ELECTRICAL PANELBOARD NON-FUSIBLE DISCONNECT SWITCH; XX/YY/ZZ WHERE X INDICATES AMPERAGE, Y INDICATES # OF POLES, AND Z INDICATES NEMA RATING **MISCELLANEOUS** C/L CENTERLINE A.F.F. ABOVE FINISHED FLOOR ATS AUTOMATIC TRANSFER SWITCH CONDUIT WEATHERPROOF GND GROUND GROUND FAULT CIRCUIT INTERRUPTER MT MOUNT GCSC GULF COAST STATE COLLEGE

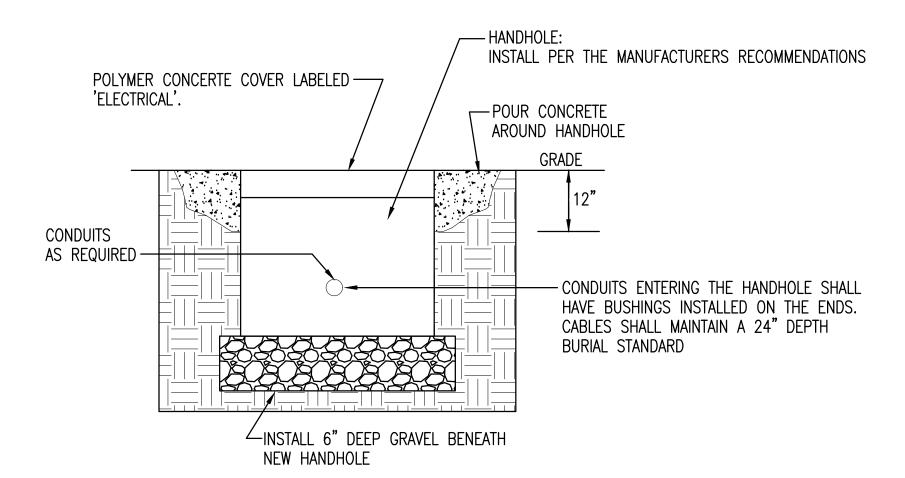

### ELECTRICAL MAINTENANCE/HANDHOLE DETAIL NOT TO SCALE

#### ELECTRICAL GENERAL NOTES

- 1. ENTIRE ELECTRICAL INSTALLATION SHALL BE IN ACCORDANCE WITH THE LATEST ACCEPTED EDITION OF THE NATIONAL ELECTRICAL CODE AND ALL LOCAL CODES.
- 2. ALL ELECTRICAL WORK AND MATERIALS USED IN THIS PROJECT SHALL BE NEW, UNDERWRITERS' LABORITORIES (UL) LISTED AND LABELED, AND SHALL BE FURNISHED AND INSTALLED BY THE CONTRACTOR UNLESS NOTED OTHERWISE.
- 3. WHERE CONFLICTS OCCUR ON ELECTRICAL DRAWINGS BETWEEN DRAWINGS, SPECIFICATIONS AND CODES, THE MOST STRINGENT REQUIREMENT THAT APPLIES SHALL BE ADHERED TO.
- 4. NEW POLE SHALL BE FURNISHED WITH A SURGE PROTECTION DEVICE INSTALLED IN THE HANDHOLE NEAR THE BASE OF THE POLE.
- 5. ALL WIRING SHALL BE COPPER AND INSTALLED IN CONDUIT.
- 6. THE ELECTRICAL CONTRACTOR SHALL COORDINATE ALL WORK WITH THE CIVIL AND LANDSCAPE DRAWINGS. UTILIZE COMMON TRENCHES FOR INSTALLATION OF CONDUITS WHERE POSSIBLE. PRIOR TO INSTALLATION OF CONDUIT, THE ELECTRICAL CONTRACTOR WILL BE REQUIRED TO PLAN ALL CONDUIT ROUTING WITH THE OTHER CONTRACTORS PERFORMING SITE WORK. SUBMIT A RECORD OF THIS COORDINATION TO THE ARCHITECT PRIOR TO STARTING SITE WORK. IF ONE CONTRACTOR IS PERFORMING ALL CONDUIT SITE WORK, THEN A QUALIFIED ELECTRICIAN WILL BE REQUIRED TO BE ON SITE APPROVING THE CONDUIT INSTALLATION/ROUTING PRIOR TO COVERING THE CONDUITS.

#### ALL CONDUIT UNDERGROUND WORK SHALL COMPLY WITH THE GENERAL CONDITIONS BELOW:

COMPOSITION — THE CONDUITS SHALL BE CORROSION RESISTANT AND SHALL BE MADE OF EPC—80—PVC (SCHEDULE 80) IAW NEMA TC—2. THE CONDUITS SHALL BE APPROPRIATELY LABELED INDICATING THE COMPOSITION MATERIAL. CONDUITS SHALL HAVE A SLEEVE OR BELL END TYPE COUPLING AND SHALL BE WATERTIGHT WHEN ASSEMBLED.

INSTALLATION — INSTALLATION OF UNDERGROUND CONDUITS SHALL BE A MINIMUM OF 24" BELOW GRADE. INSTALL IN COMMONS TRENCH WHERE SHOWN ON THE CIVIL PLANS. IN MAINTENANCE HOLES WITH KNOCKOUTS, CONDUITS SHALL START AT THE BOTTOM KNOCKOUT, ALLOWING FOR UPWARD EXPANSION IN THE MAINTENANCE HOLES. THE CONTRACTOR SHALL PROVIDE OTHER PROTECTIVE MEASURES, CONCRETE CAP, ETC., IN THOSE AREAS WHERE THE MINIMUM GROUND COVER CANNOT BE ACHIEVED.

#### BENDS AND SEALING.

THE SUM OF BENDS IN ALL DIRECTIONS SHALL NOT EXCEED A TOTAL OF 180 DEGREES. CONDUITS SHALL HAVE BELL ENDS AND ENTER A MAINTENANCE HOLES PERPENDICULAR TO THE SURFACE OF THE WALL THROUGH WHICH IT IS ENTERING. ALL CONDUITS ENTERING MAINTENANCE HOLES MUST BE SEALED. UNIVERSAL CONDUIT PLUGS OR REMOVABLE PUTTY SEALANTS MAY BE USED. UPON COMPLETION OF CONDUIT SECTIONS, A TEST MANDREL ¼" (6.4MM) SMALLER THAN THE INSIDE DIAMETER OF THE CONDUIT SHALL BE PULLED THROUGH TWO DIAGONALLY OPPOSITE CONDUITS TO ENSURE PROPER ALIGNMENT. IN ADDITION, ALL CONDUITS SHALL BE CLEARED OF LOOSE MATERIALS SUCH AS CONCRETE, MUD, DIRT, STONES, ETC.

#### PULL ROI

ALL VACANT CONDUITS SHALL BE PROVIDED WITH A WATERPROOF CORROSION RESISTANT MULE TAPE FOR FUTURE CABLE INSTALLATION. THE PULL ROPE /MULE TAPE SHALL EXTEND INTO THE MAINTENANCE HOLE AND BE SECURED TO THE CABLE RACK OR PULLING IRON, ETC.

#### SPACERS AND TRACER WIRE

ALONG THE LENGTH OF THE CONDUIT RUN, IF THE CONDUITS ARE INSTALLED BY TRENCHING, SPACERS SHALL BE PLACED AT AN INTERVAL OF FOUR (4) SPACERS PER 20 FEET AND CABLE WARNING TAPE SHALL BE BURIED ONE (1) FOOT BELOW THE SURFACE AND SHALL FOLLOW THE DUCT ROUTE. THE TAPE SHALL BE A MINIMUM OF THREE INCHES WIDE AND ORANGE IN COLOR WITH THE APPROPRIATE WARNING MESSAGE. AT LEAST ONE CONDUIT SHALL HAVE TRACER WIRE OR BE OTHERWISE LOCATABLE FROM THE SURFACE.

#### UTILITY SEPARATION

COMMUNICATIONS CONDUITS AND CABLE SHALL MAINTAIN A MINIMUM SEPARATION OF 12 INCHES FROM ALL TRADES.

		LIGHTING	FIXTURE	SCHEDULE
MARK	MANUFACTURER AND CATALOG No.	LAMPS No. TYPE	MOUNTING	REMARKS
PL2	GARDCO #ECF-1-2-215LA-641A-NW-UNV (FINISH) POLE: VALMONT #R290860106-D1	LED	POLE ARM MOUNT 33' ABOVE GRADE	SINGLE-PIECE DIE-CAST ALUMINUM HOUSING, POWDER COAT FINISH, 4000K, UNIVERSAL VOLTAGE, PROVIDE WITH WATTSTOPPER NWTL-111, ROUND TAPERED ALUMINUM POLE
PL4	GARDCO #ECF-1-4-215LA-641A-NW-UNV (FINISH) POLE: VALMONT #R290860106-D1	LED	POLE ARM MOUNT 33' ABOVE GRADE	SINGLE-PIECE DIE-CAST ALUMINUM HOUSING, POWDER COAT FINISH, 4000K, UNIVERSAL VOLTAGE, PROVIDE WITH WATTSTOPPER NWTL-111, ROUND TAPERED ALUMINUM POLE
2PL4	GARDCO #ECF-2-4-215LA-641A-NW-UNV (FINISH) POLE: VALMONT #R290860106-D2	LED	POLE ARM MOUNT 33' ABOVE GRADE	SINGLE-PIECE DIE-CAST ALUMINUM HOUSING, POWDER COAT FINISH, 4000K, UNIVERSAL VOLTAGE, PROVIDE TWO FIXTURES MOUNTED AT 180°, PROVIDE WITH WATTSTOPPER NWTL-111. ROUND TAPERED ALUMINUM POLE.

<sup>\*</sup> ALL FINISHES AND FIXTURE COLOR TEMPERATURE SHALL BE DIRECTED BY ARCHITECT/OWNER PRIOR TO ORDERING FIXTURES

FLORIDA
ARCHITECTS
LICENSE #AA0002730
648 Florida Avenue
Panama City, Fl. 32401
P 850/257-5400
M. BACHITECTS
OF MINISTRA PROPERTY OF THE PROPE

Principal in Charge
David M. Bagwell
Project Number:
4166-2

No. 59251

Date Issued: 5-18-2017 Drawn By: D.C. Checked By:

D.B. Revisions:

BAGWELL ENGINEERING
216 E. Government St.
Pensacola Fl. 32502

216 E. Government St. Pensacola, FL 32502 Phone: (850) 462-8040 FL Authorization No. 30167 FL PE No. 59251 Job Number: 15-019


ST STATE COLLEGE PHASE 3

> RICAL ELGEND, RE SCHEDULE ENERAL NOTES

CONSTRUCTION DOCUMENTS

Sheet Number

<u>-</u>1

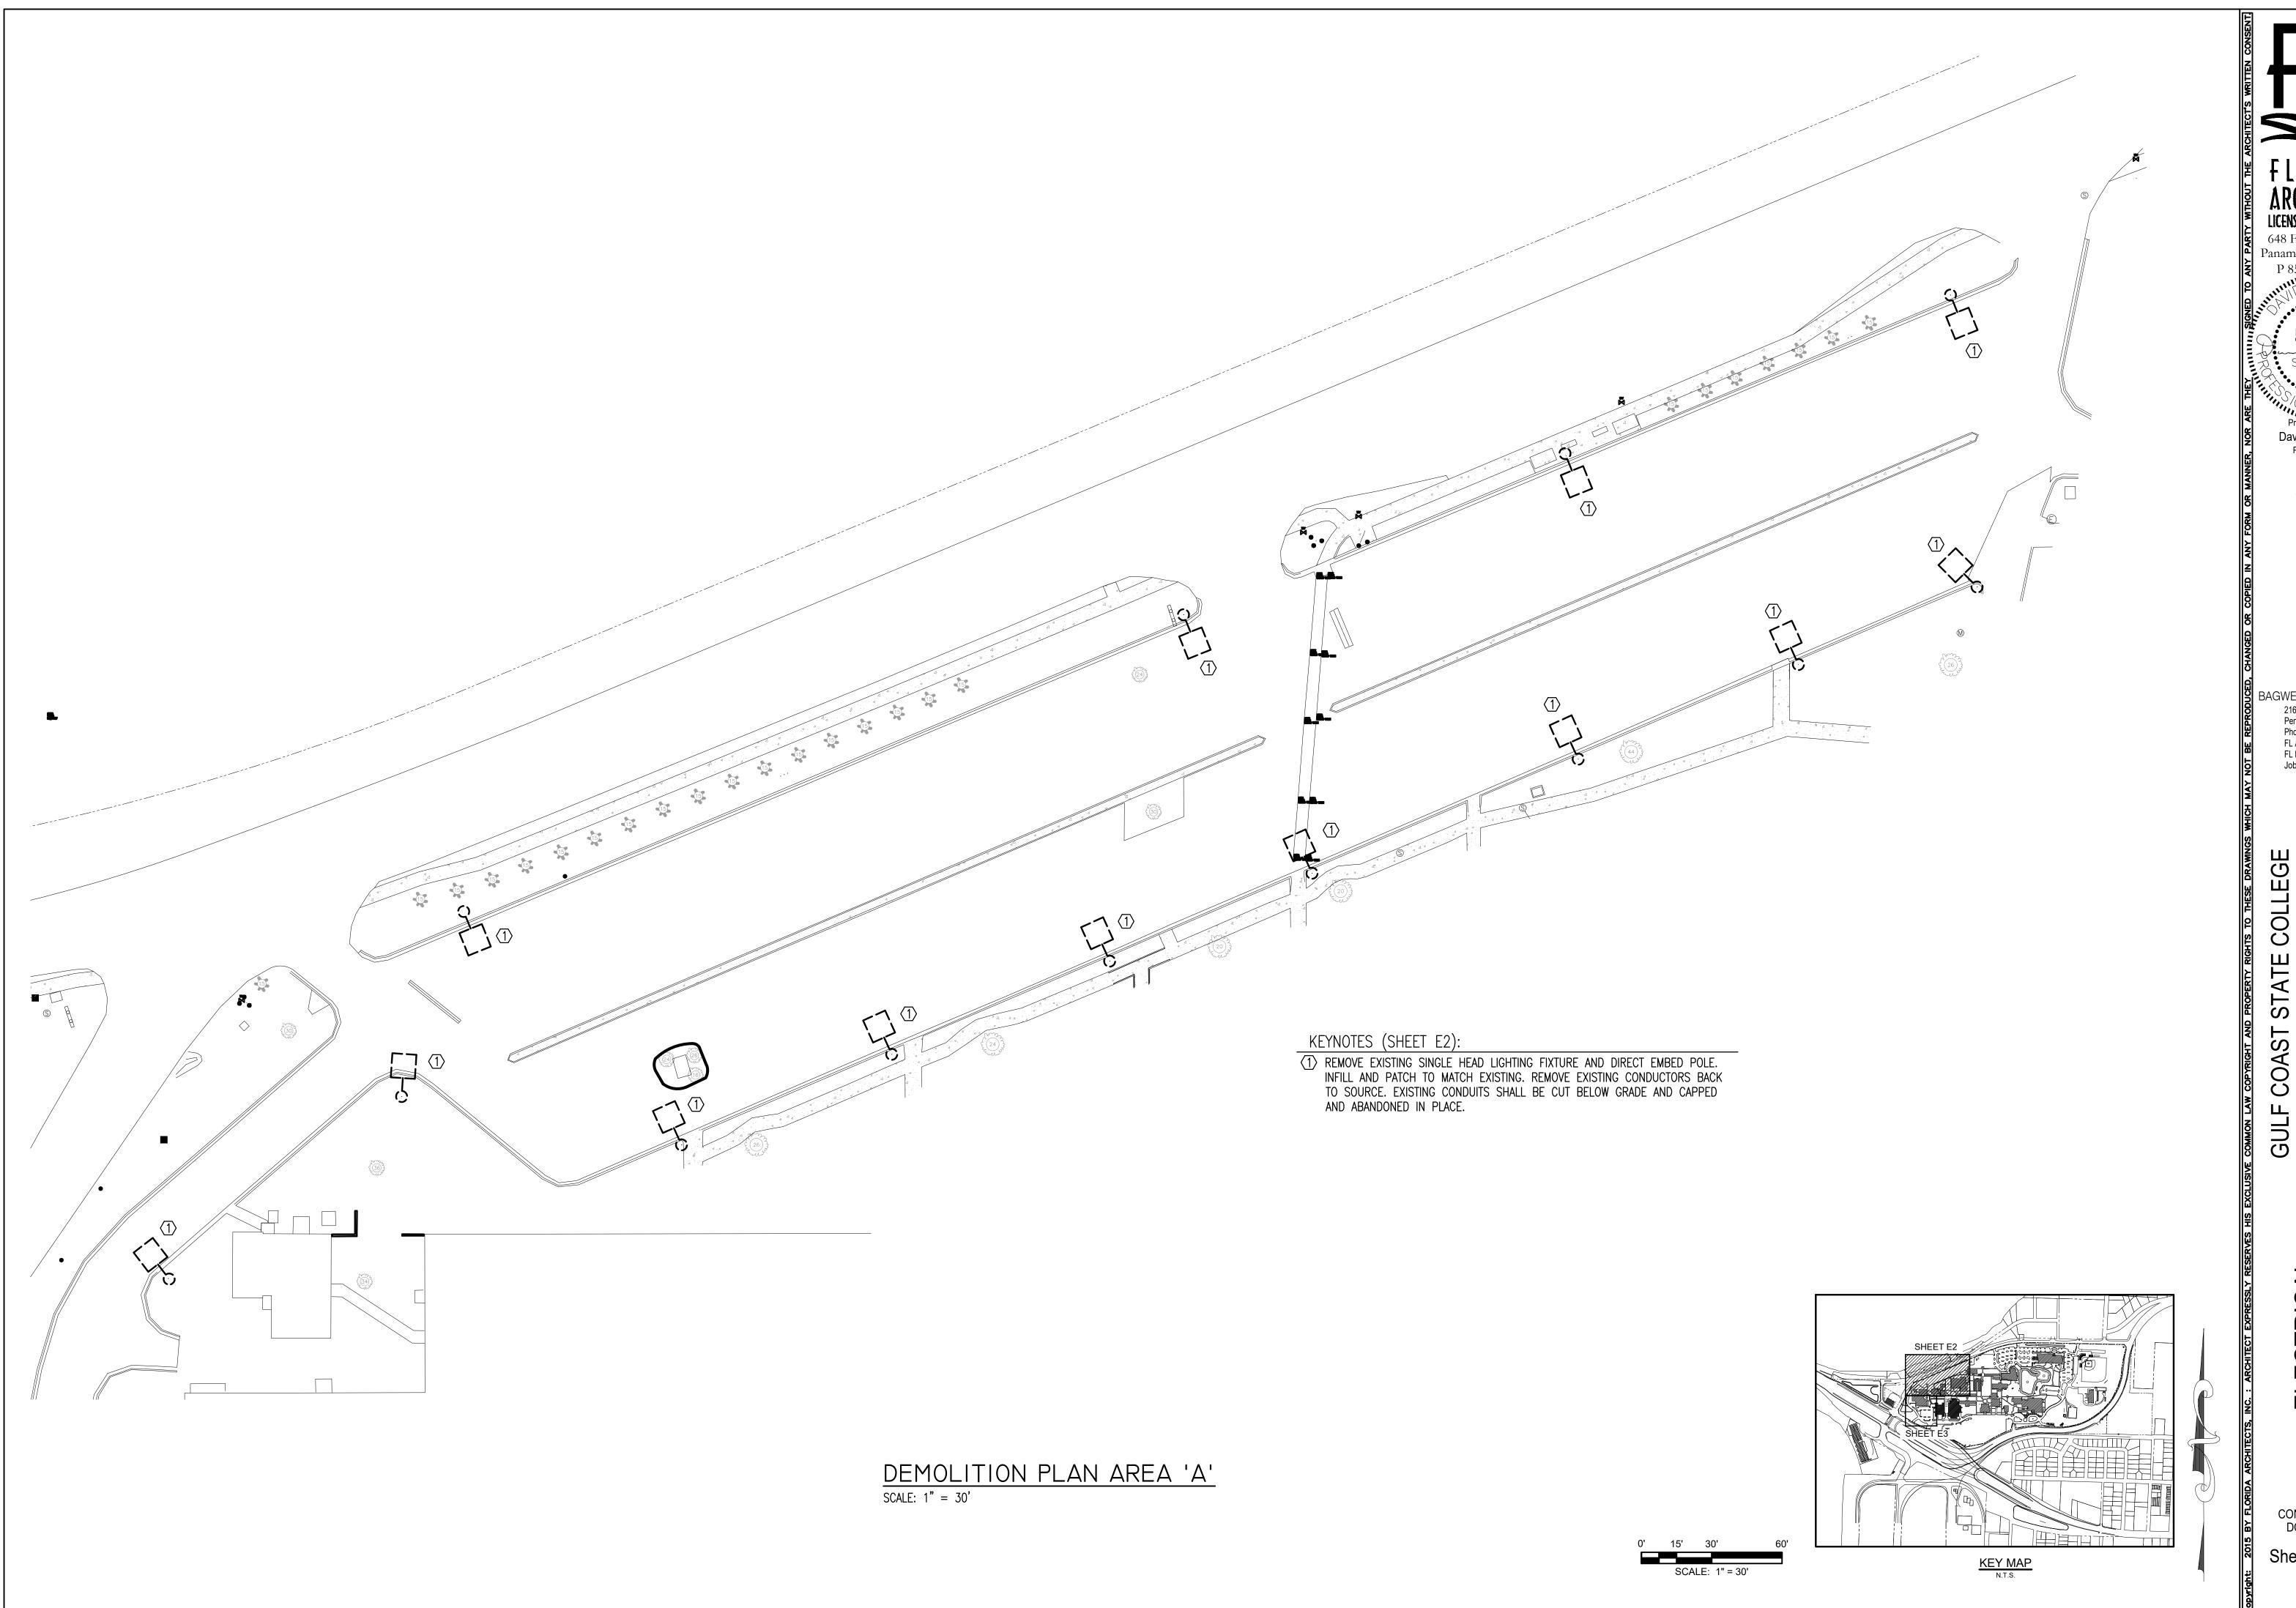


Panama City, Fl. 32401


David M. Bagwell Project Number: Date Issued: 5-18-2017 Drawn By: Checked By:


D.B. Revisions:

BAGWELL ENGINEERING 216 E. Government St. Pensacola, FL 32502 Phone: (850) 462-8040 FL Authorization No. 30167 FL PE No. 59251 Job Number: 15-019

CONSTRUCTION DOCUMENTS

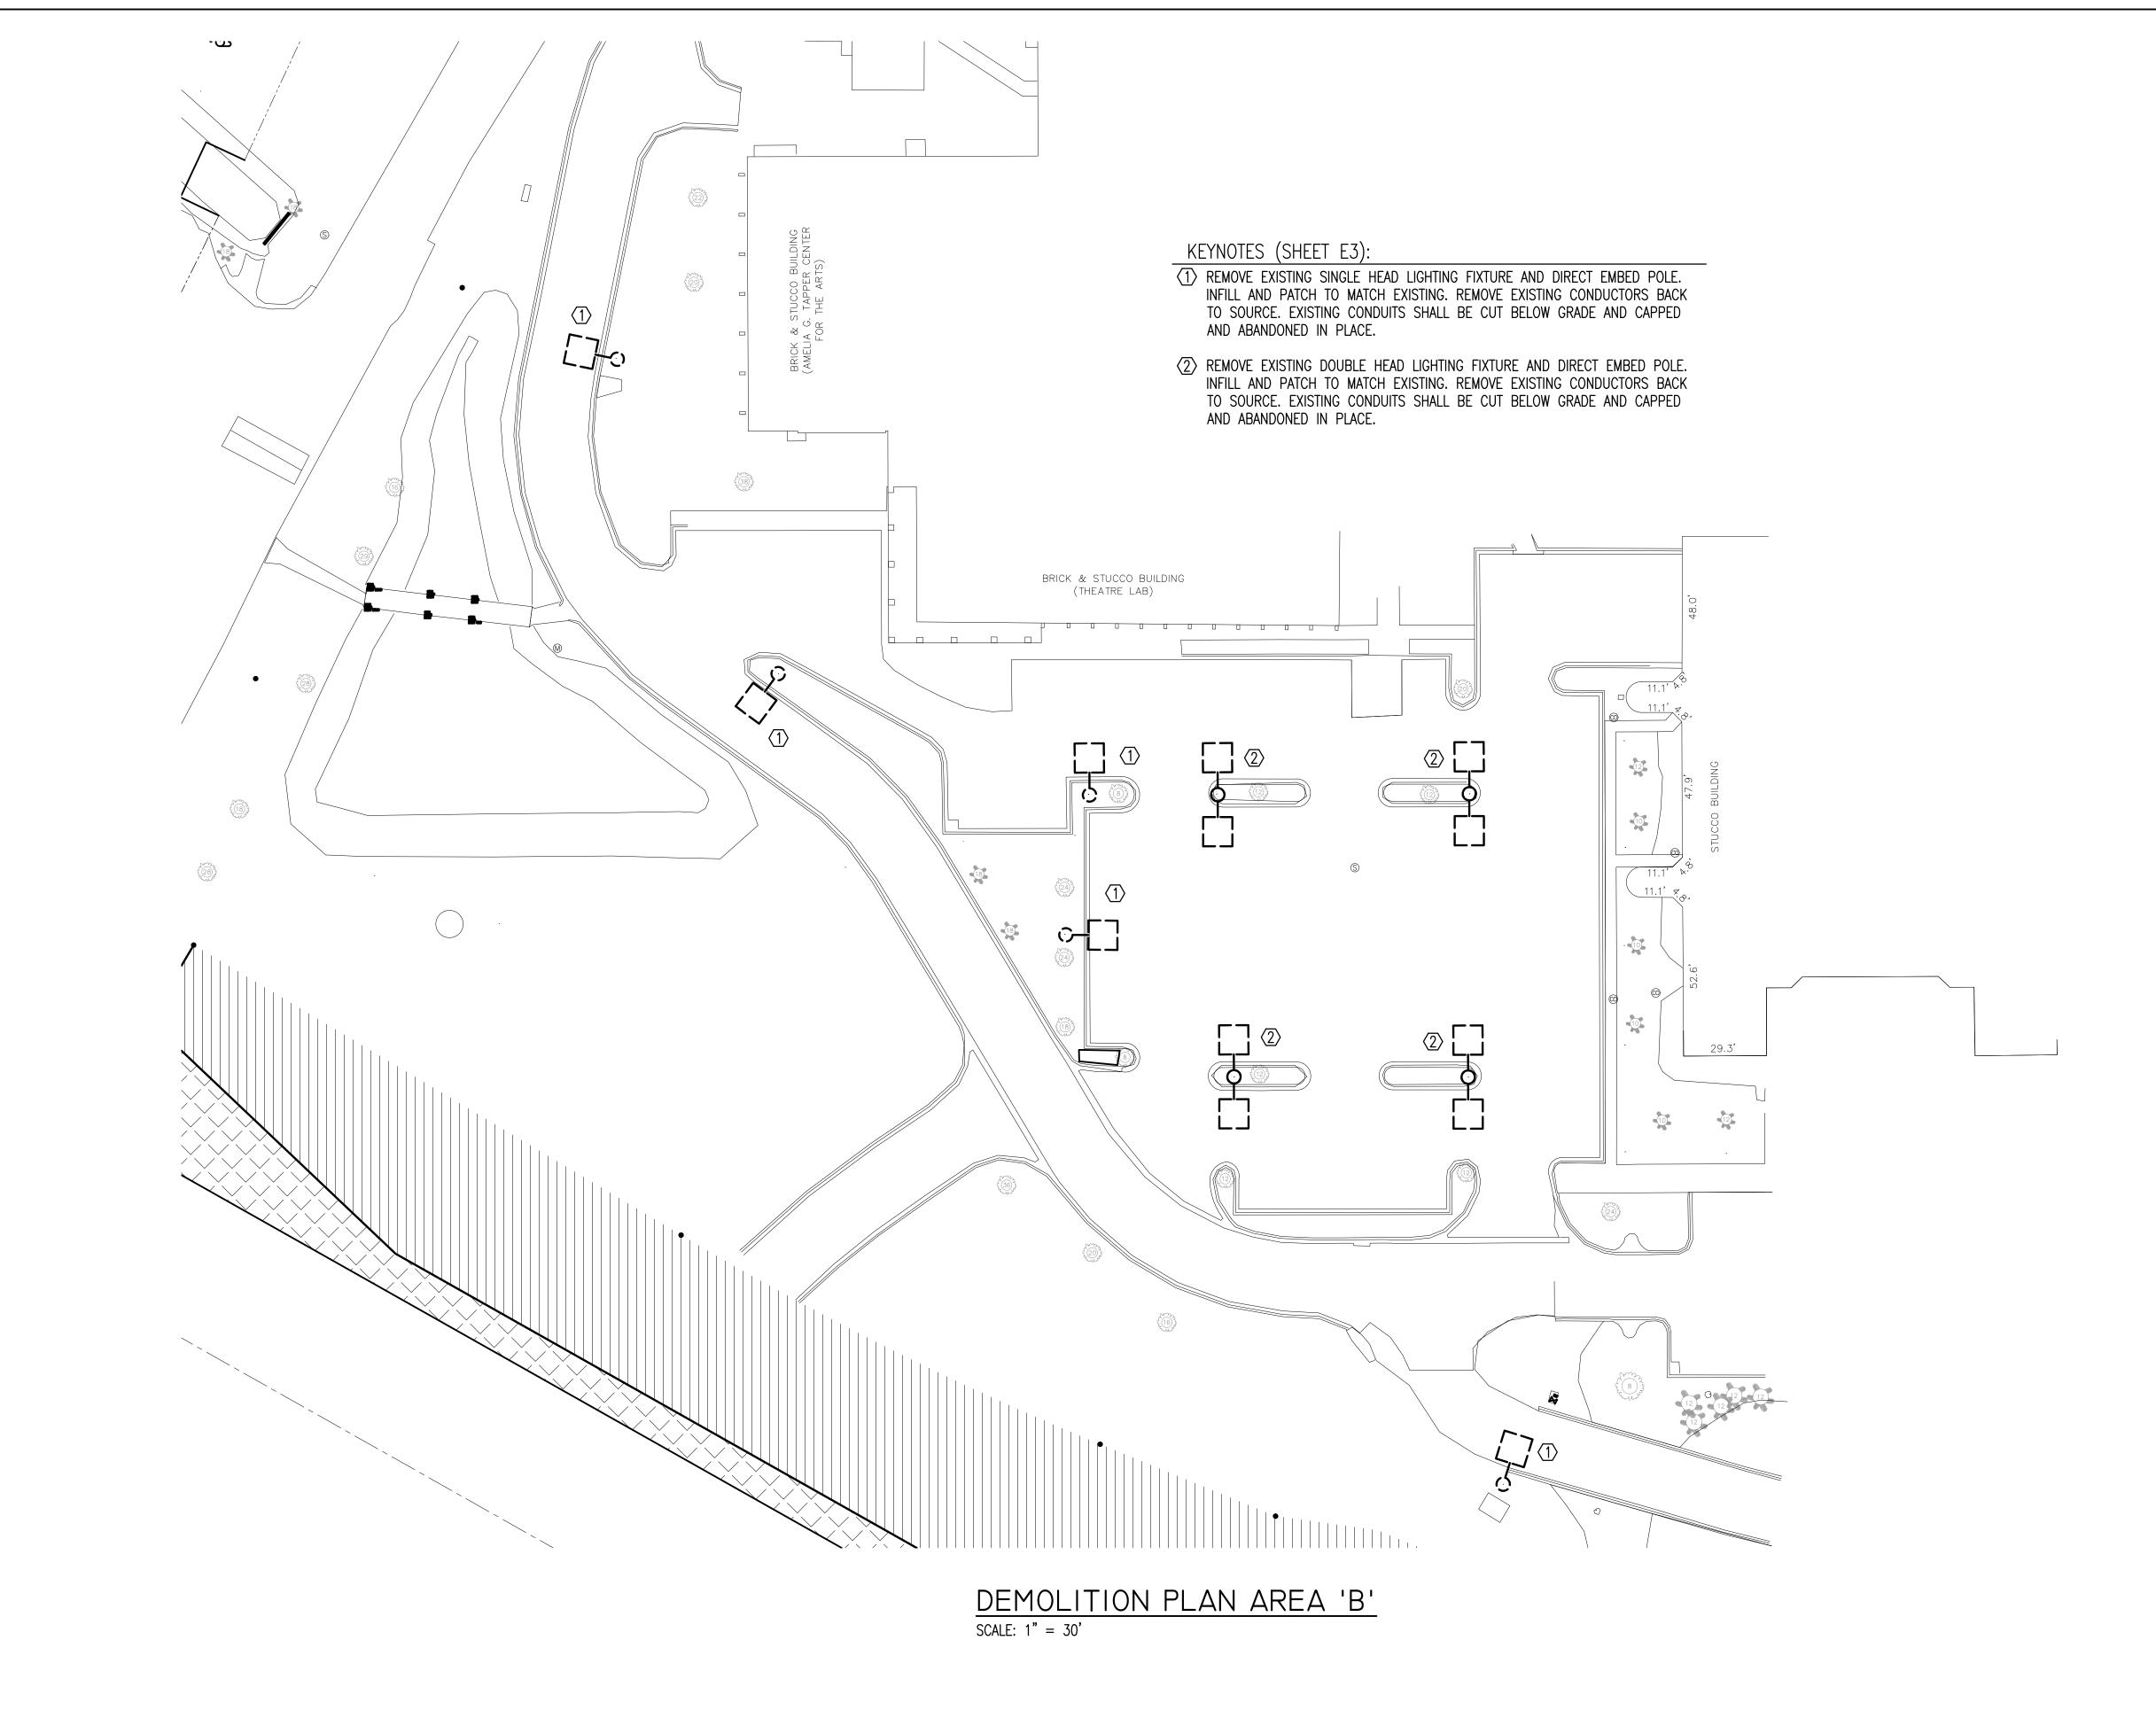

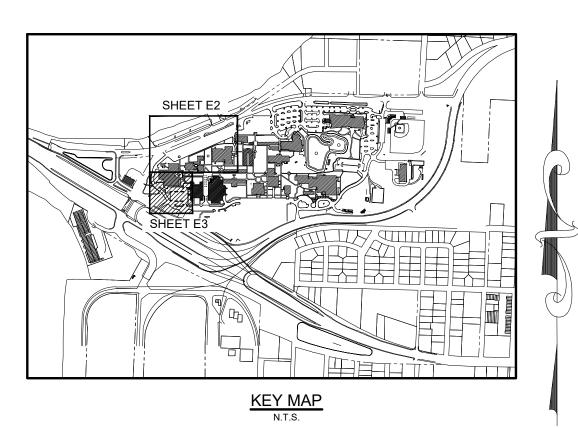

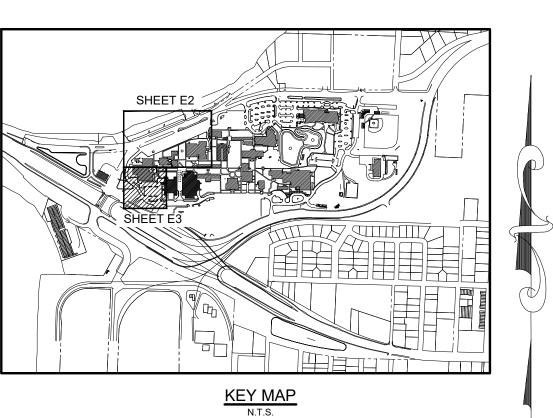

LICENSE #AAOOO2730 648 Florida Avenue Panama City, Fl. 32401

> David M. Bagwell Project Number: 4166-2 Date Issued: 5-18-2017 Drawn By:

> > D.C. Checked By: D.B. Revisions:


BAGWELL ENGINEERING 216 E. Government St. Pensacola, FL 32502 Phone: (850) 462-8040

FL Authorization No. 30167 FL PE No. 59251 Job Number: 15-019

COLLEGE COAST GULF

CAMPUS IMPROVEMENTS

CONSTRUCTION DOCUMENTS

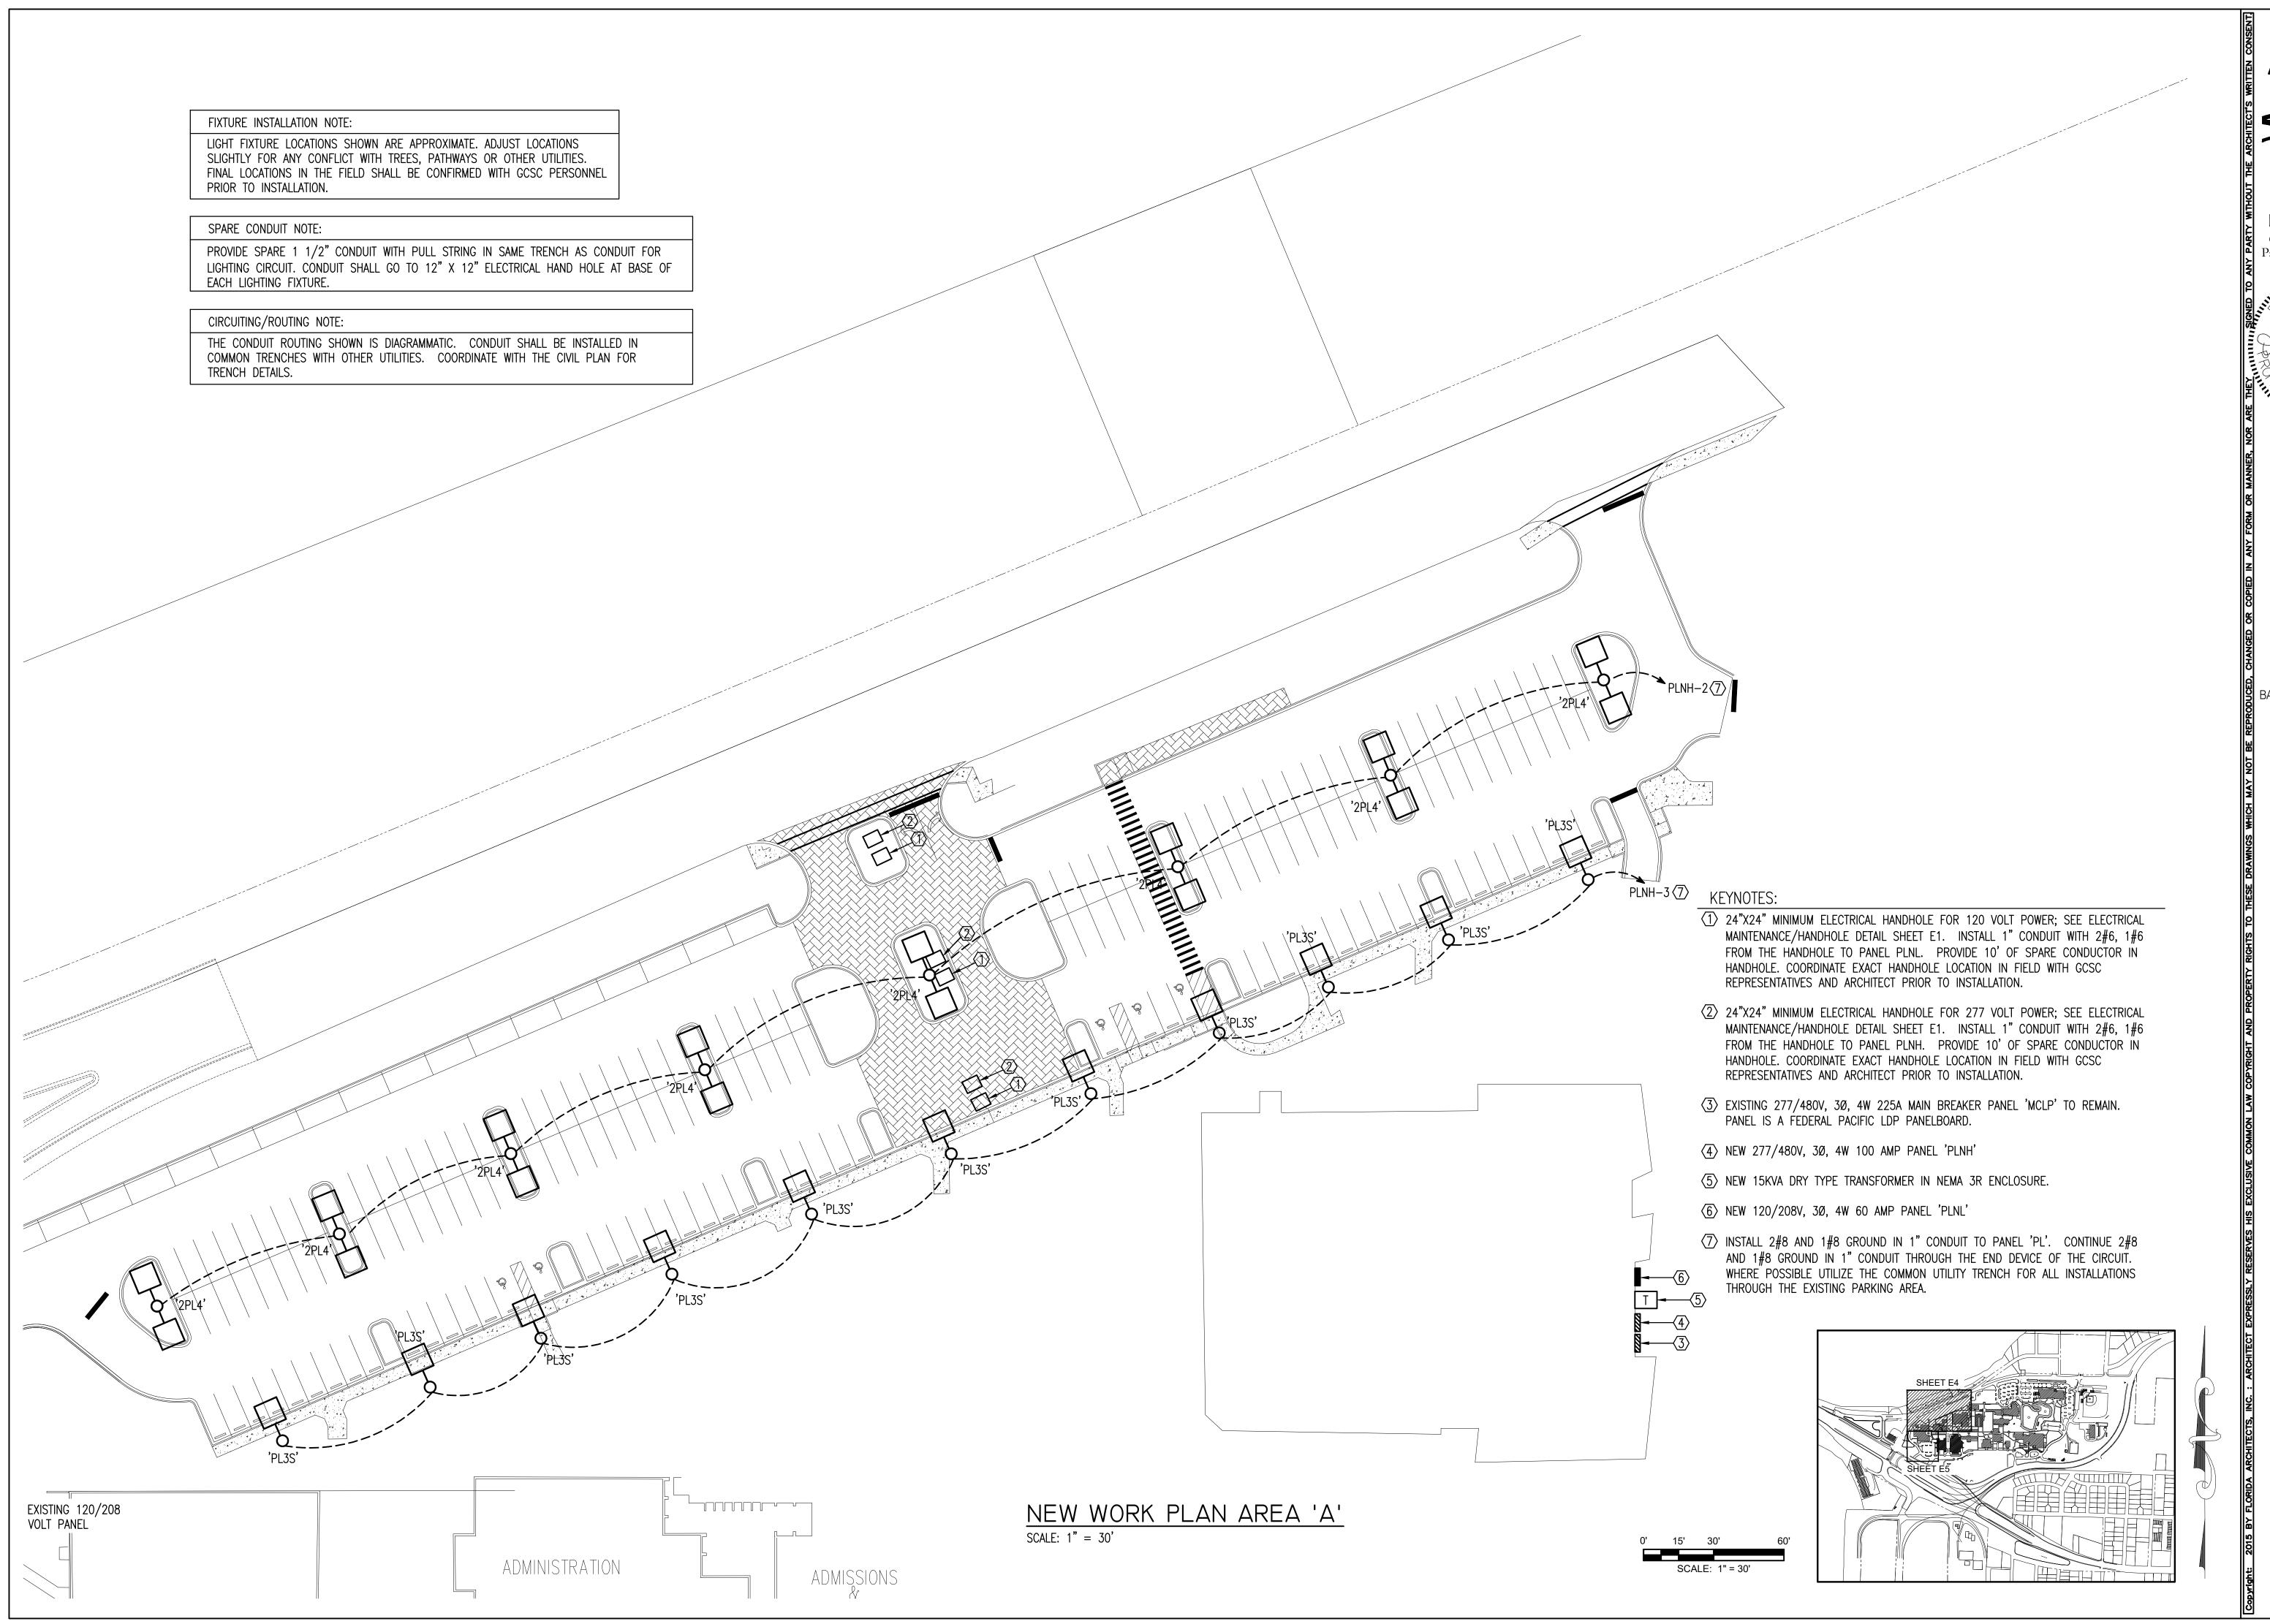

LICENSE #AAOOO2730 648 Florida Avenue

Panama City, Fl. 32401

David M. Bagwell Project Number: 4166-2 Date Issued: 5-18-2017

Drawn By:

Checked By: D.B.

Revisions:

BAGWELL ENGINEERING 216 E. Government St.


Pensacola, FL 32502 Phone: (850) 462-8040 FL Authorization No. 30167 FL PE No. 59251 Job Number: 15-019

COLLEGE STATE PHASE COAST

CAMPUS IMPROVEMENTS

NEW WORK PLAN AREA 'A'

CONSTRUCTION DOCUMENTS

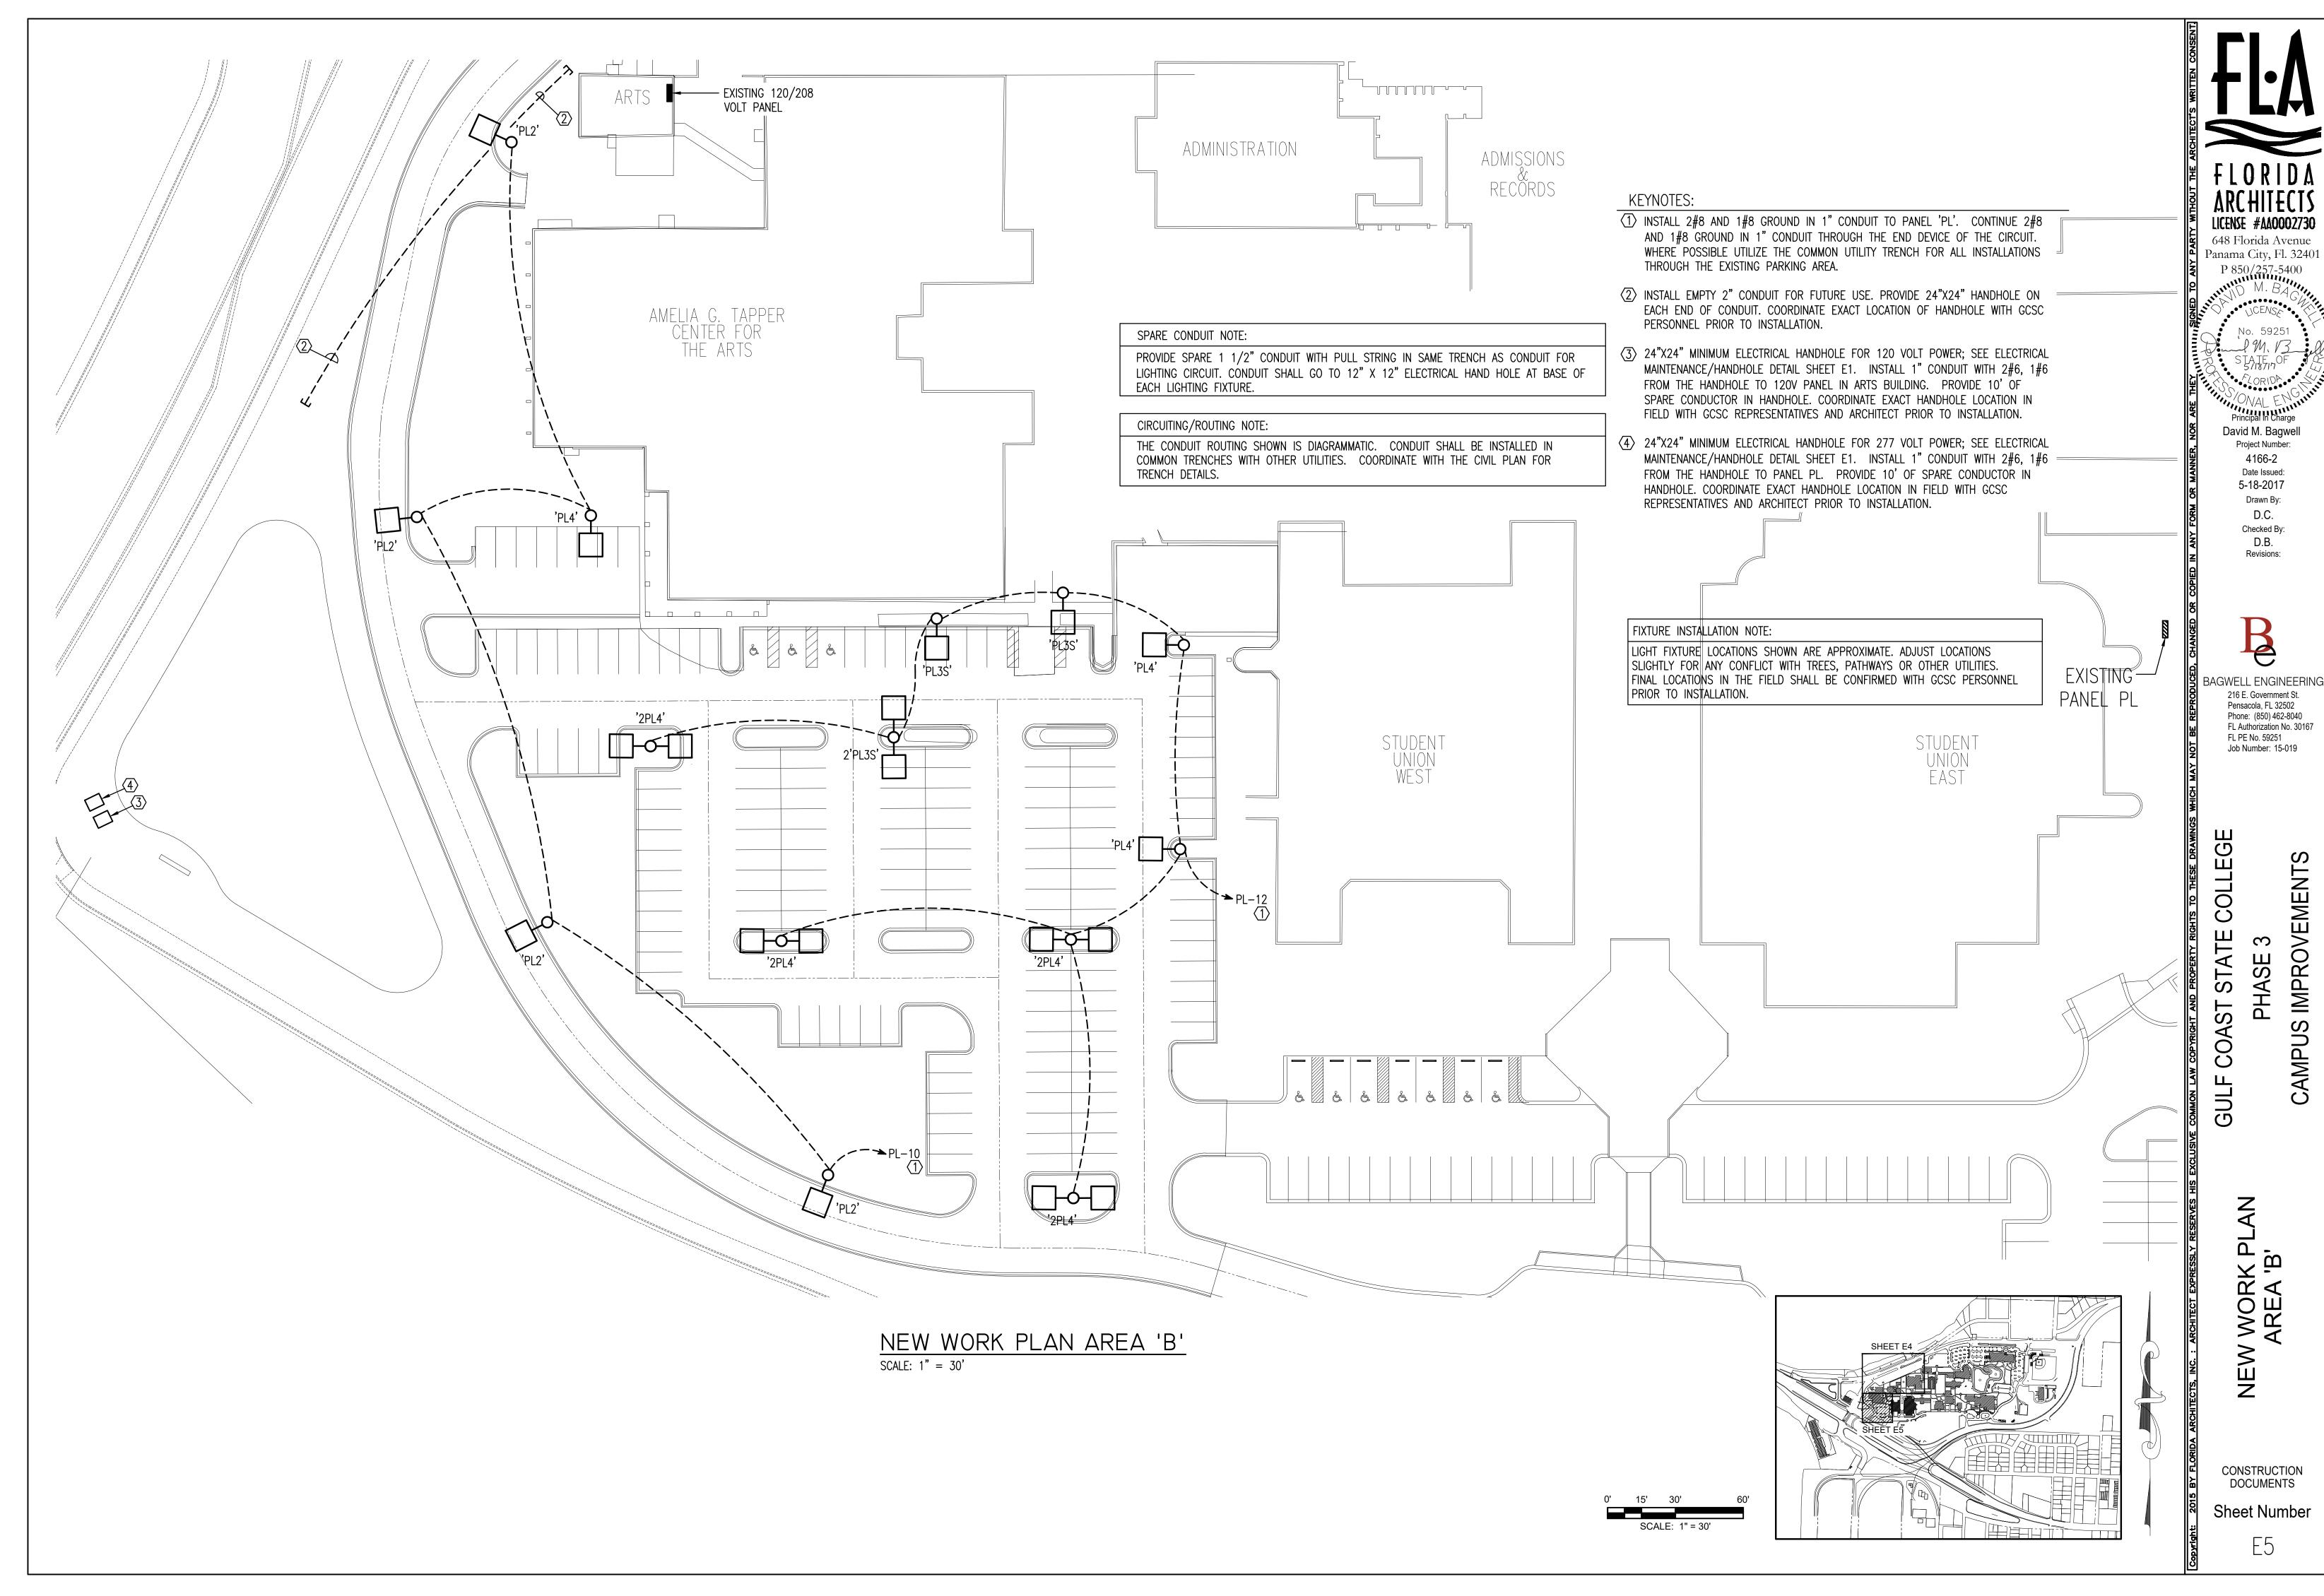

LICENSE #AA0002730


648 Florida Avenue Panama City, Fl. 32401

David M. Bagwell

Phone: (850) 462-8040 FL Authorization No. 30167


Job Number: 15-019

## ELECTRICAL POLE BASE FOR FIXTURES NOT TO SCALE

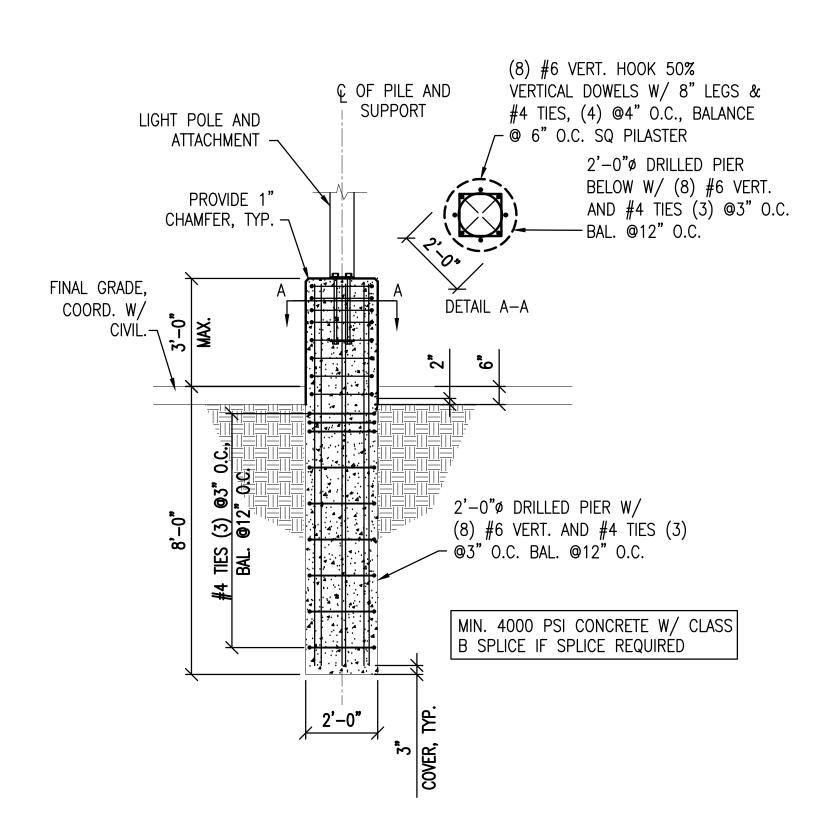

## STRUCTURAL LIGHT POLE BASE DETAIL NOT TO SCALE

DETAIL PROVIDED IS FOR A CAST IN PLACE POLE BASE. IF THE CONTRACTOR ELECTS TO INSTALL A PRECAST POLE BASE, SIGNED AND SEALED SHOP DRAWINGS SHALL BE PROVIDED BY A SPECIALTY ENGINEER FOR REVIEW.

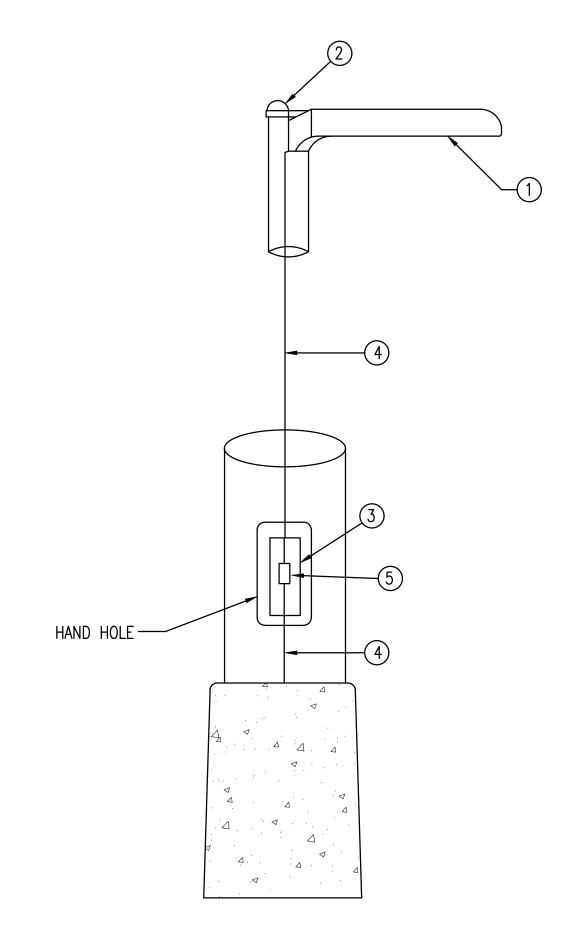

ITEM #	DESCRIPTION
1)	LED FIXTURE; SEE LIGHTING FIXTURE SCHEDULE FOR EXACT FIXTURE
2	NWTL TWIST LOCK LIGHTING CONTROLLER
3	HANDHOLE
4)	#8 WIRING TO LIGHT FIXTURE
5	SURGE SUPPRESSOR

NWTL-III-IP MOUNTING ON TOP OF POLE
NOT TO SCALE



Project Number:

4166-2

Date Issued:
5-18-2017

Drawn By:

D.C.

Checked By:

D.B.

Revisions:

BAGWELL ENGINEERING
216 E. Government St.

216 E. Government St. Pensacola, FL 32502 Phone: (850) 462-8040 FL Authorization No. 30167 FL PE No. 59251 Job Number: 15-019

COAST STATE COLLEGE
PHASE 3

**IMPROVEMENTS** 

GULF COAS AILS GAMPUS

ECTRICAL DETAIL

CONSTRUCTION DOCUMENTS


Sheet Number

6

OU AN	MP MAIN BREAKER			EXI	STII	NG	PAN	EL	PL				
CKT	LOAD DESCRIPTION	BREA POLE	AKER AMP	KVA A	/PH/ B	ASE C	KVA A	/PH/ B	ASE C		AKER POLE	LOAD DESCRIPTION	CK
1	ILLUMINATED MAP	1	20(1)	.1			1.16			1)20		PARKING LOT LIGHTS	2
	PARKING LOT LIGHTS	1	20①		2.55			1.62		1)20		PARKING LOT LIGHTS	4
	PARKING LOT LIGHTS	1	20①			1.62			1.62	①20		PARKING LOT LIGHTS	6
	PARKING LOT LIGHTS	1	20①	1.86			1.16			①20		PARKING LOT LIGHTS	8
	SPARE	1	20					1.06		<u> </u>		ROADWAY LIGHTS	10
	SPARE	1	20						2.59	<u> </u>	1	WEST PARKING LOT LIGHTS	12
	SPARE	1	20							20	1	SPARE	14
	SPARE	1	20							20	1	SPARE	16
	SPACE ONLY	1									1	SPACE ONLY	18
	SPACE ONLY	1									1	SPACE ONLY	20
21	SPACE ONLY	1									1	SPACE ONLY	22
	SPACE ONLY	1									1	SPACE ONLY	24
25	SPACE ONLY	1									<b>A</b>	<b>A</b>	26
	SPACE ONLY	1								30	3	SURGE SUPPRESSOR	28
29	SPACE ONLY	1								•	<u> </u>	•	30
TOTAL CONNECTED KVA 4.28 5.23 5.83 (2) CONNECT TO EXISTING SPARE BREAKER  MINIMUM INTERRUPTING CAPACITY: 22,000 AMPS SYMMETRICAL  A B C													

	1						IEL			1				
CKT	LOAD DESCRIPTION	BREA	KER	KVA	./PH/	4SE	KVA	·/PH	ASE	BRE	AKER		DESCRIPTION	CKT
CKI	LOAD DESCRIPTION	POLE	AMP	Α	В	С	Α	В	С	AMP	POLE	LOAD	DESCRIPTION	CN
1	ENTRANCE ISLAND SIGN CIRCUIT	1	20	.1			1.70			20	1	PARKING LOT	LIGHTS	2
3	SIDEWALK LIGHTS	1	20		.85					20	1	SPARE		4
5	CENTER ISLAND SIGN CIRCUIT	1	20			.1				20	1	SPARE		6
7	SIDEWALK SIGN CIRCUIT	1	20	.1						20	1	SPARE		8
9	SPARE	1	20							20	1	SPARE		10
11	SPACE ONLY	1									1	SPACE ONLY		12
13	SPACE ONLY	1									1	SPACE ONLY		14
15	SPACE ONLY	1									1	SPACE ONLY		16
17	SPACE ONLY	1									1	SPACE ONLY		18
19	SPACE ONLY	1									1	SPACE ONLY		20
21	SPACE ONLY	1									1	SPACE ONLY		22
23	SPACE ONLY	1									1	SPACE ONLY		24
25	<b>A</b>	4	4	1.0						4	4	<b>A</b>		26
27	PANEL 'PLNL' VIA TRANSFORMER	3	25		1.0					30	3	SURGE SUPP	PRESSOR	28
29	₩	<b>+</b>	•			1.0				<b>V</b>	<b>+</b>	<b>V</b>		30

	208 VOLT 3Ø 4W MP MAIN BREAKER	CIRC	UIT				PA: IEL			CHEI	DULI	SURFACE MOUNTE NEMA 4X ENCLOS PANEL SHALL BE	URE
CKT	LOAD DESCRIPTION	BRE/ POLE		KVA A	/PH/ B	ASE C	KVA A	VPH B	ASE C		AKER POLE	LOAD DESCRIPTION	CKT
1	ENTRANCE ICLAND CION OIDOUIT	1 0 L L				0					1 0		
7	ENTRANCE ISLAND SIGN CIRCUIT	1	20	1.0	1.0					20	1	SPARE	2
5	CENTER ISLAND SIGN CIRCUIT	1	20		1.0	1.0				20		SPARE	4
5	SIDEWALK SIGN CIRCUIT		20			1.0				20		SPARE	6
/	SPARE	1	20							20	1	SPARE	8
9	SPARE	1	20							20	1	SPARE	10
11	SPACE ONLY	1									1 1	SPACE ONLY	12
13	SPACE ONLY	1									1	SPACE ONLY	14
15	SPACE ONLY	1									1	SPACE ONLY	16
17	SPACE ONLY	1									1	SPACE ONLY	18
19	SPACE ONLY	1								<b>A</b>	<b>A</b>	<b>A</b>	20
21	SPACE ONLY	1								30	3	SURGE SUPPRESSOR	22
23	SPACE ONLY	1								<b>+</b>	<b>V</b>	<b>+</b>	24
MINIM	TOTAL CONNECTED KVA  MINIMUM INTERRUPTING CAPACITY: 10,000 AMPS SYMMETRICAL  A B C												

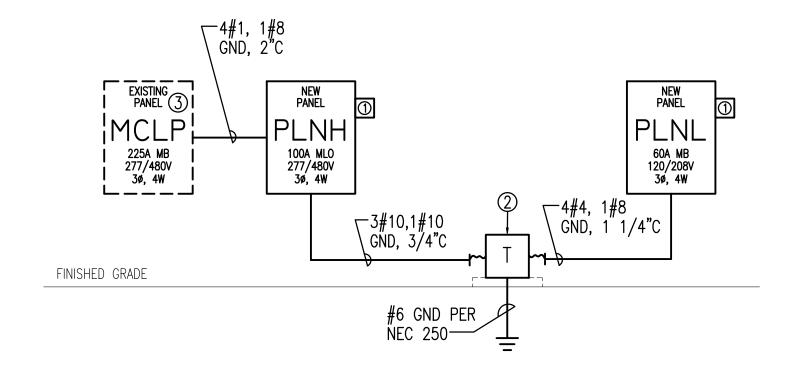

### PANEL 'PLNH' POWER RISER DIAGRAM

PANEL 'PLNH' POWER RISER KEYNOTES:

- ① SURGE SUPPRESSOR; EQUAL TO SURGE SUPPRESSION INC. #SKB3Y2D3 INSTALL PER MANUFACTURER'S RECOMMENDATIONS; SURGE SUPPRESSOR SHALL BE NEMA 3R RATED.
- ② GENERAL PURPOSE 15KVA 480△- 208Y/120V, 3ø, 4W, DRY TYPE TRANSFORMER. PROVIDE NEMA 3R ENCLOSURE, WEATHERSHIELDS AND CONCRETE PAD 4" THICK AND 4" LARGER THAN FOOTPRINT OF TRANSFORMER.
- ③ INSTALL NEW 100 AMP/3 POLE BREAKER IN EXISTING SPACE TO SERVE NEW PANEL.



David M. Bagwell
Project Number:
4166-2
Date Issued:
5-18-2017
Drawn By:

Drawn By:
D.C.
Checked By:
D.B.
Revisions:



GWELL ENGINEERIN
216 E. Government St.
Pensacola, FL 32502
Phone: (850) 462-8040
FL Authorization No. 30167
FL PE No. 59251
Job Number: 15-019

ST STATE COLLEGE PHASE 3

PH/ CAMPUS IMF

POWER RISER
AGRAM AND PANEL
SCHEDULES

CONSTRUCTION DOCUMENTS

Sheet Number

7